

LEVEL:	NO. OF DOORS:
GF	1
τοται	1

LEVEL:	NO. OF DOORS:
GF	1
TOTAL	1

LEVEL:	NO. OF DOORS:
B1	1
TOTAL	1

MB MAILBOX TO FUTURE DETAIL

OPAQUE WINDOW

PRE-FABRICATED

PLANTERBOX

RECYCLING BIN

SKY LIGHT

STORAGE

DETAIL

MV

OP

PS

RCL

SK

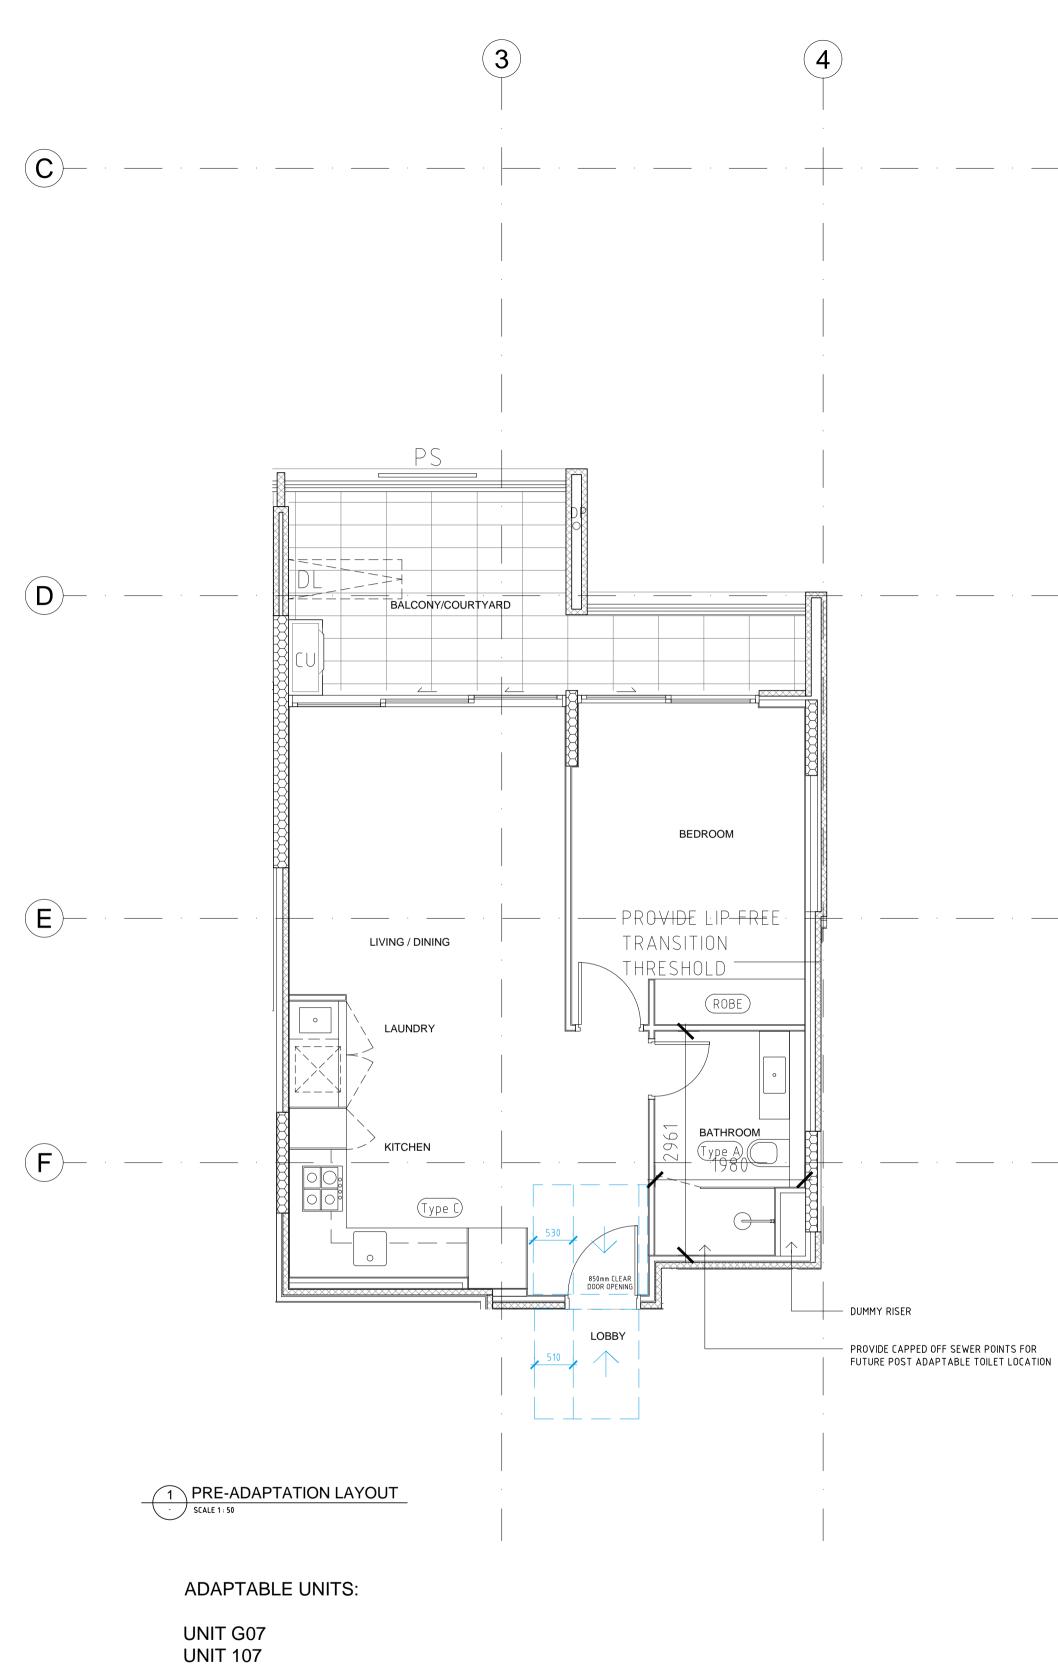
ST

MECHANICAL RISER TO FUTURE


SLIDING PRIVACY SCREEN

RETRACTABLE CLOTHES LINE


CONSTRUCTION CERTIFICATE NO. I certify that work completed in accordance with these plans and specification will comply with the regulations referred to in section 81A(5) of the Environmental Planning and 07.06.2019 ISSUED FOR D&C USED DURING CONSTRUCTION UPDATE AS PER FER ISSUED FOR REVIEW DESCRIPTION lords Group P - 02 9191 0622 Level 7/80 George St, Parramatta NSW 2150 ARCHITECT: ABN 36 147 035 550 P - 02 9698 8140 E - info@pbdarchitects.com.au W - www.pbdarchitects.com.au Level 2, 52 Albion Street, Surry Hills NSW 2010 PROJECT: 11-15 MITCHELL AVENUE, JANNALI JANUARY 2019 DRAWING TITLE: DOOR SCHEDULE 02 SCALE: DRAWING NO: ISSUE: 1:10 @ A1 / 1:20 @ A3 A6102 PROJECT NO: 1747





UNIT 207 UNIT 307

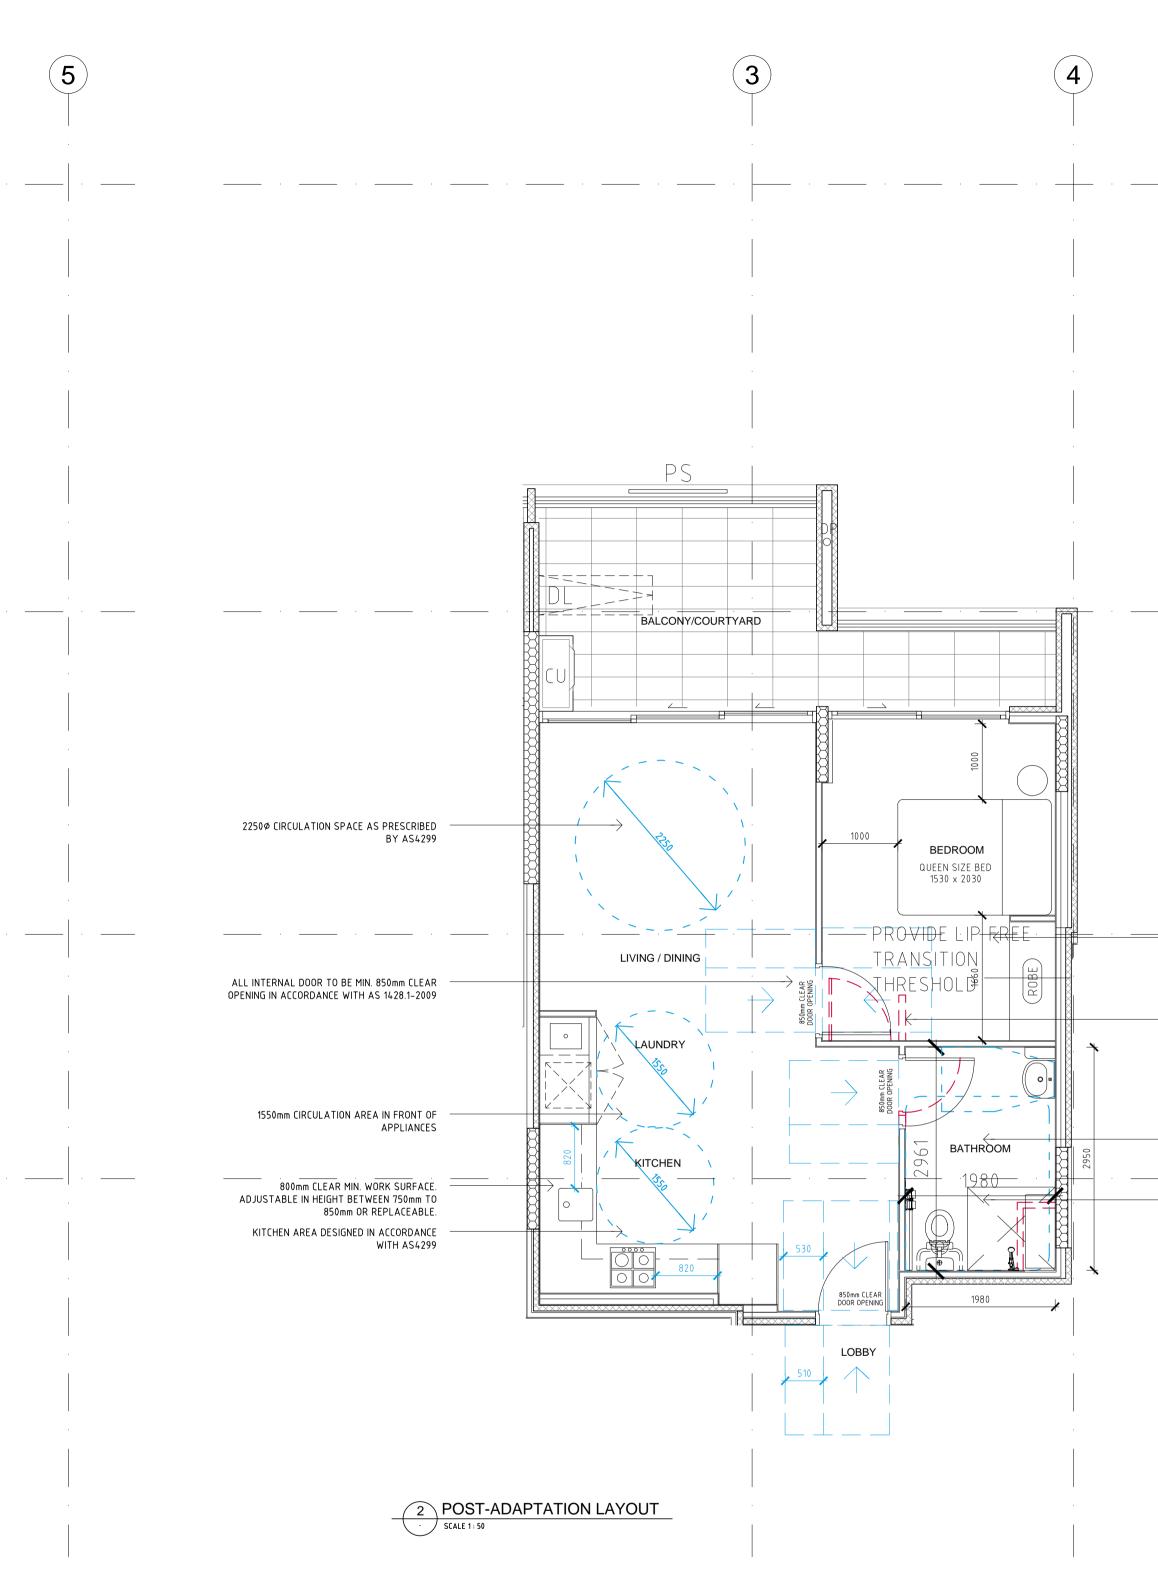

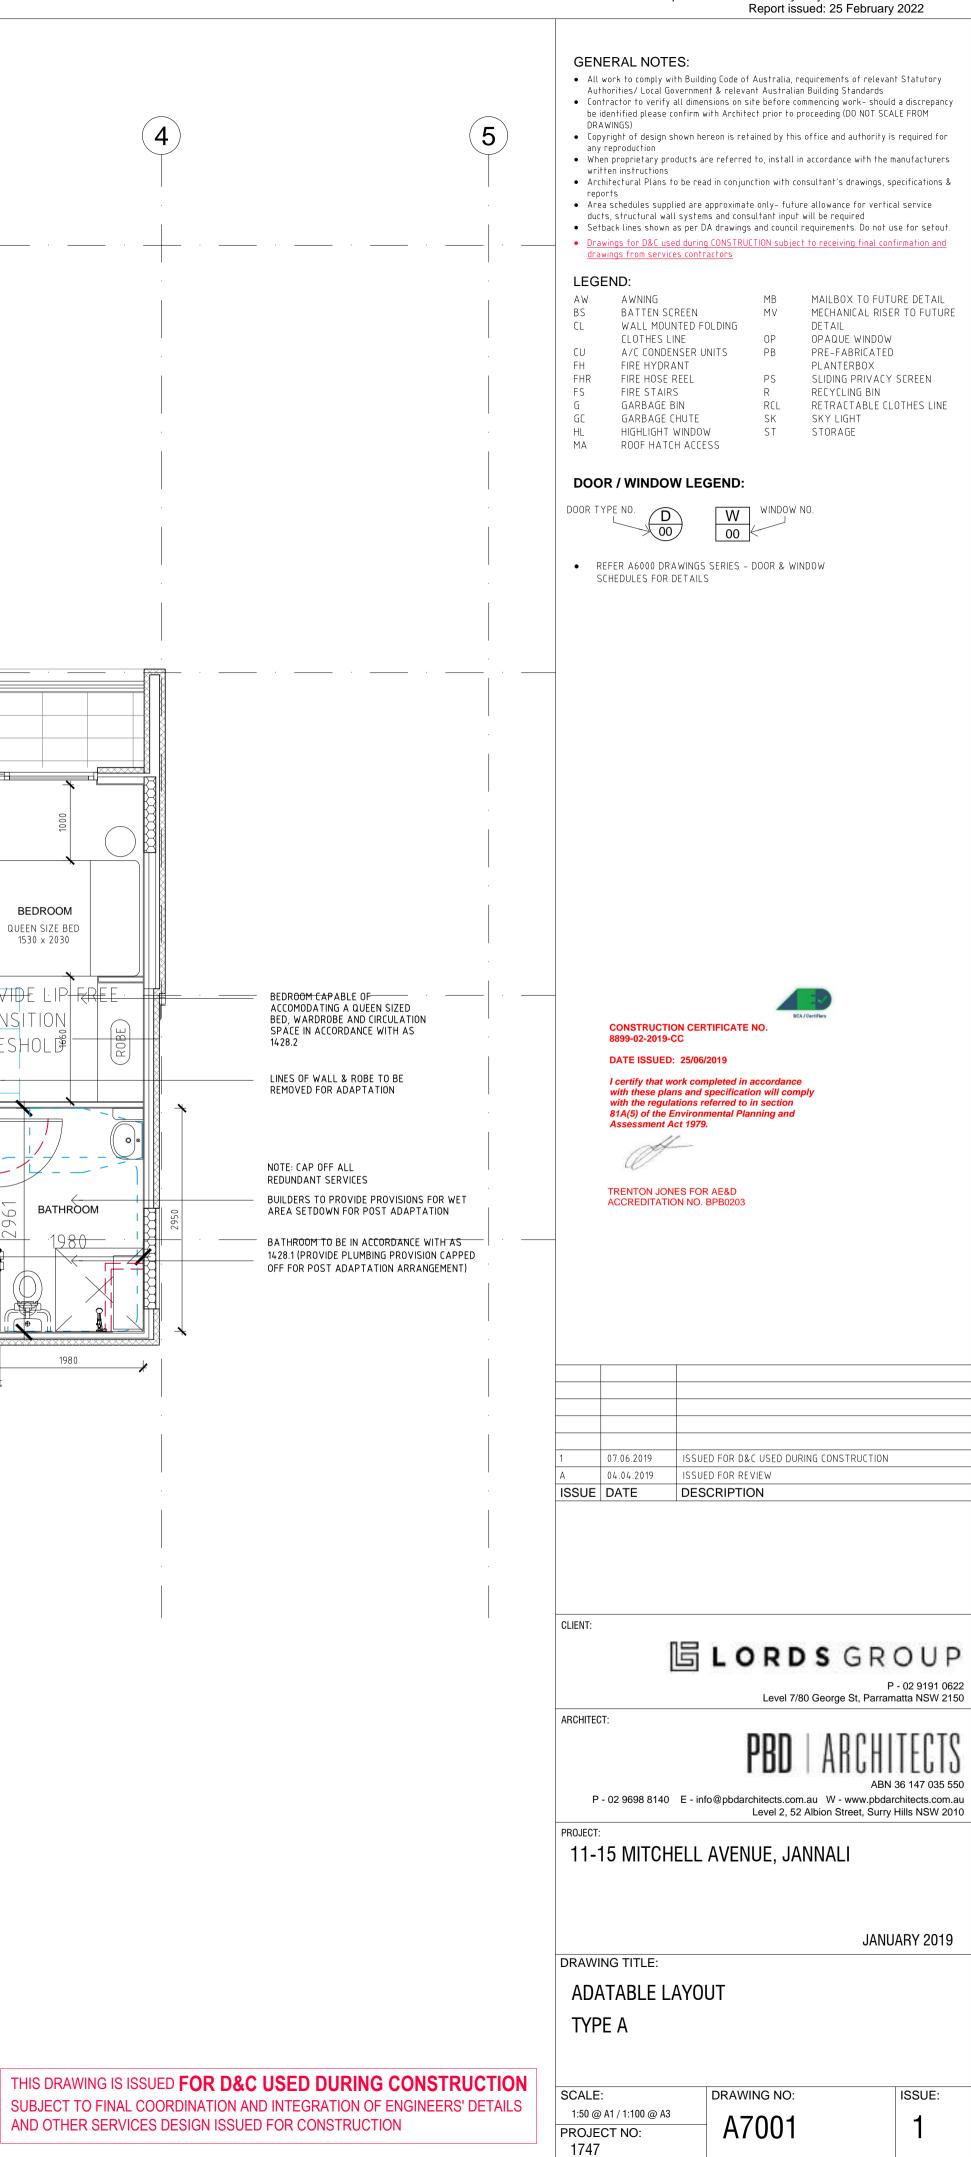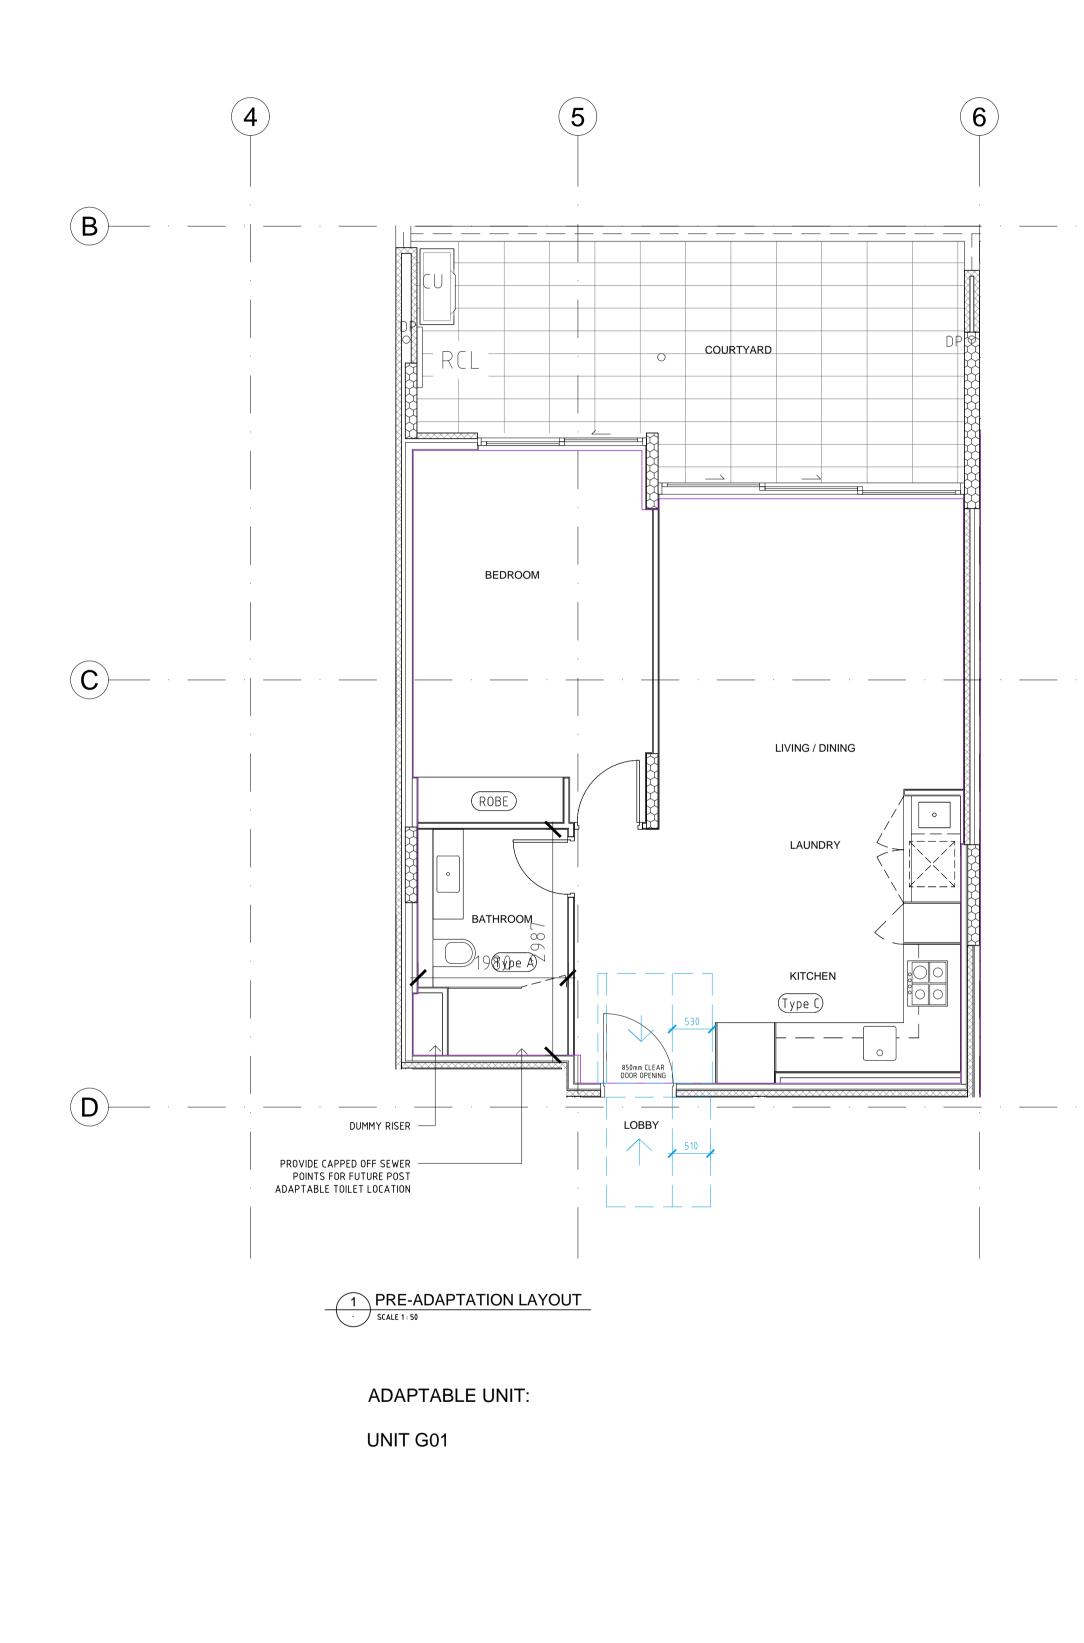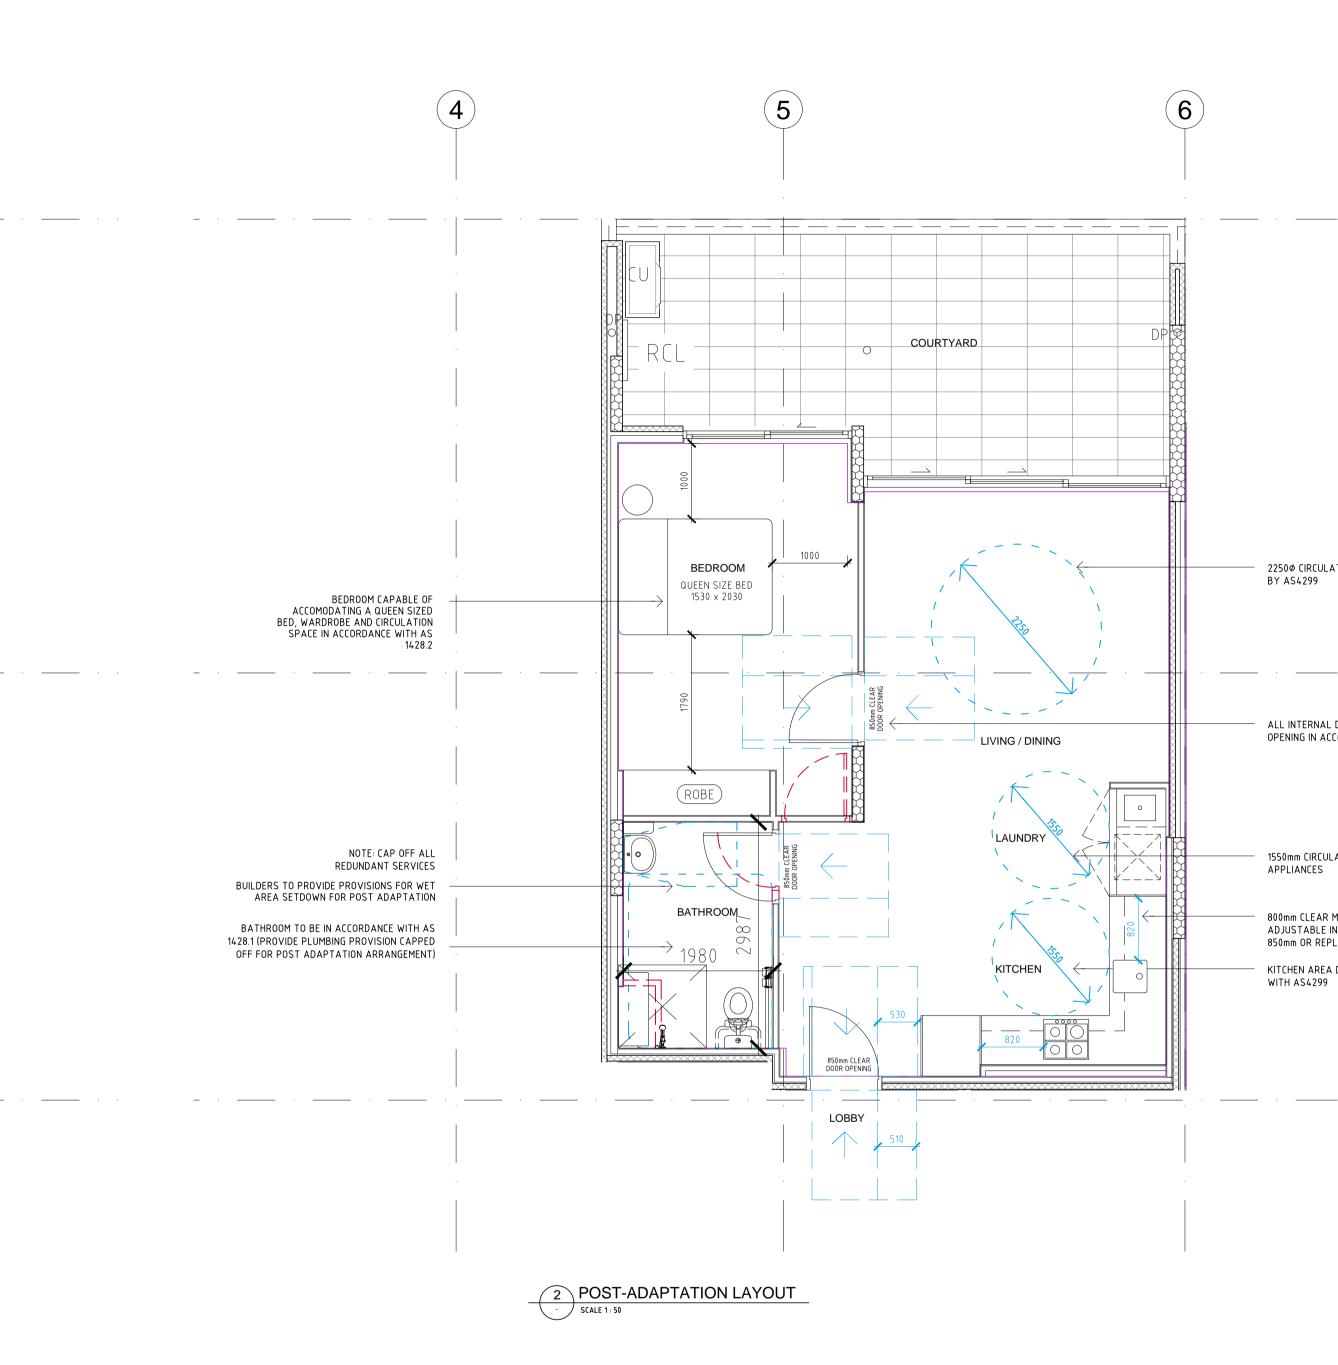Mitchell Ave Developments P/L vs Forte Sydney Constructions P/L







Mitchell Ave Developments P/L vs Forte Sydney Constructions P/L Report issued: 25 February 2022

GENERAL NOTES:

- All work to comply with Building Code of Australia, requirements of relevant Statutory Authorities/ Local Government & relevant Australian Building Standards
- Contractor to verify all dimensions on site before commencing work- should a discrepancy be identified please confirm with Architect prior to proceeding (D0 NOT SCALE FROM DRAWINGS)
- Copyright of design shown hereon is retained by this office and authority is required for any reproduction
- When proprietary products are referred to, install in accordance with the manufacturers
- written instructions - Architectural Plans to be read in conjunction with consultant's drawings, specifications &
- Area schedules supplied are approximate only- future allowance for vertical service ducts, structural wall systems and consultant input will be required
 Setback lines shown as per DA drawings and council requirements. Do not use for setout.
- <u>Drawings for D&C used during CONSTRUCTION subject to receiving final confirmation and drawings from services contractors</u>

LEGEND:

LLOLN	<i>i</i> D.		
AW	AWNING	MB	MAILBOX TO FUTURE DETAIL
BS	BATTEN SCREEN	MV	MECHANICAL RISER TO FUTURE
CL	WALL MOUNTED FOLDING		DETAIL
	CLOTHES LINE	OP	OPAQUE WINDOW
CU	A/C CONDENSER UNITS	РB	PRE-FABRICATED
FH	FIRE HYDRANT		PLANTERBOX
FHR	FIRE HOSE REEL	PS	SLIDING PRIVACY SCREEN
FS	FIRE STAIRS	R	RECYCLING BIN
G	GARBAGE BIN	RCL	RETRACTABLE CLOTHES LINE
GC	GARBAGE CHUTE	SK	SKY LIGHT
HL	HIGHLIGHT WINDOW	ST	STORAGE
MA	ROOF HATCH ACCESS		

DOOR / WINDOW LEGEND:

DOOR TYPE NO. 00 00 00 00 00 00 00

REFER A6000 DRAWINGS SERIES – DOOR & WINDOW SCHEDULES FOR DETAILS

2250¢ CIRCULATION SPACE AS PRESCRIBED BY AS4299

ALL INTERNAL DOOR TO BE MIN. 850mm CLEAR OPENING IN ACCORDANCE WITH AS 1428.1-2009


1550mm CIRCULATION AREA IN FRONT OF APPLIANCES

 800mm CLEAR MIN. WORK SURFACE.
 ADJUSTABLE IN HEIGHT BETWEEN 750mm TO
 850mm OR REPLACEABLE. KITCHEN AREA DESIGNED IN ACCORDANCE

			ECA/Certillers	
	CONSTRUCTIC 8899-02-2019-C		RTIFICATE NO.	
	DATE ISSUED:		/2019 mpleted in accordance	
	with these plan with the regula	is and tions r nviron	specification will comply referred to in section mental Planning and	
	Ø.	_		
	TRENTON JON			
	ACCREDITATIC	in no.	BPB0203	
1	07.06.2019		ED FOR D&C USED DURING CONSTRUCTION	
A ISSUE	04.04.2019 DATE		ED FOR REVIEW SCRIPTION	
	NORTH			
CLIENT:	_			
	[5	LORDSGR	OUP
			P Level 7/80 George St, Parram	- 02 9191 0622 atta NSW 2150
ARCHITEC	ЭТ:		PBD ARCHI	
P	- 02 9698 8140	E - in	ABN ; fo@pbdarchitects.com.au W - www.pbdard Level 2, 52 Albion Street, Surry I	
PROJECT:		-1 1		
-	13 MITCH	CLL	AVENUE, JANNALI	
			JANU	ARY 2019
	NG TITLE:			
	ATABLE LA	۹YO	UI	
TYP	ΈB			
SCALE 1:50 @	: 2 A1 / 1:100 @ A3			ISSUE:
	CT NO:		A7002	1

THIS DRAWING IS ISSUED FOR D&C USED DURING CONSTRUCTION SUBJECT TO FINAL COORDINATION AND INTEGRATION OF ENGINEERS' DETAILS

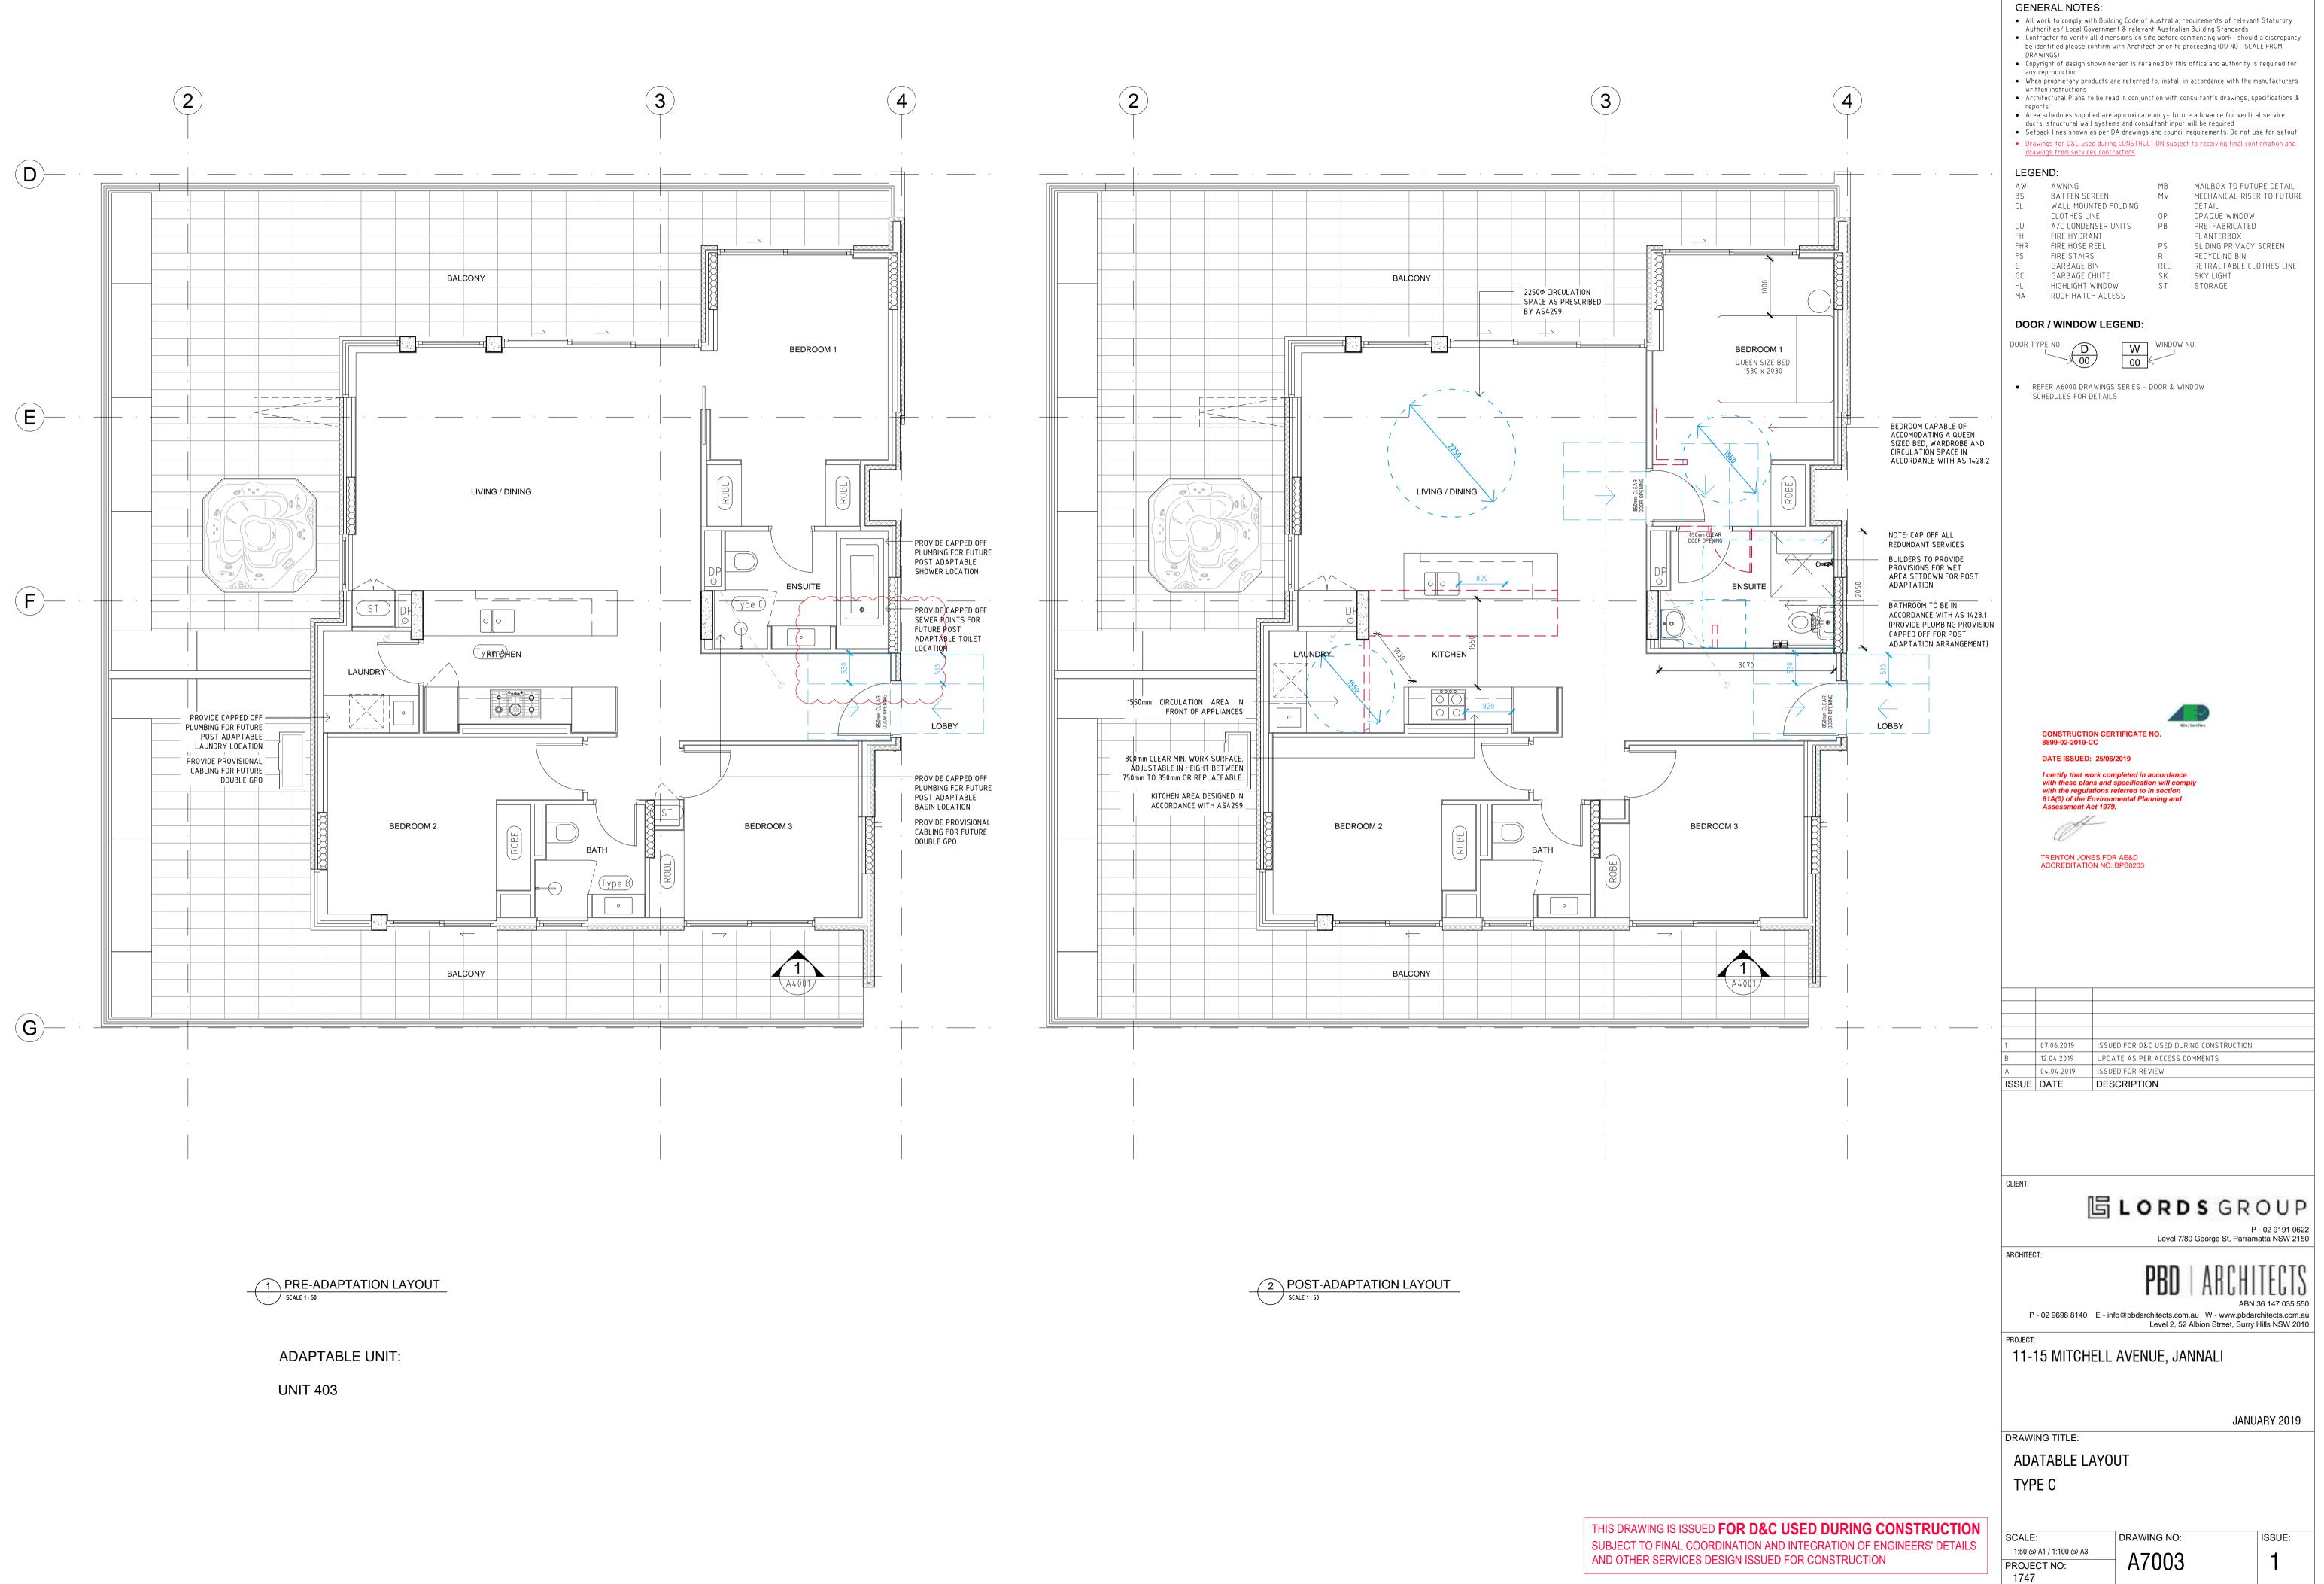
1747




Mitchell Ave Developments P/L vs Forte Sydney Constructions P/L


Report issued: 25 February 2022

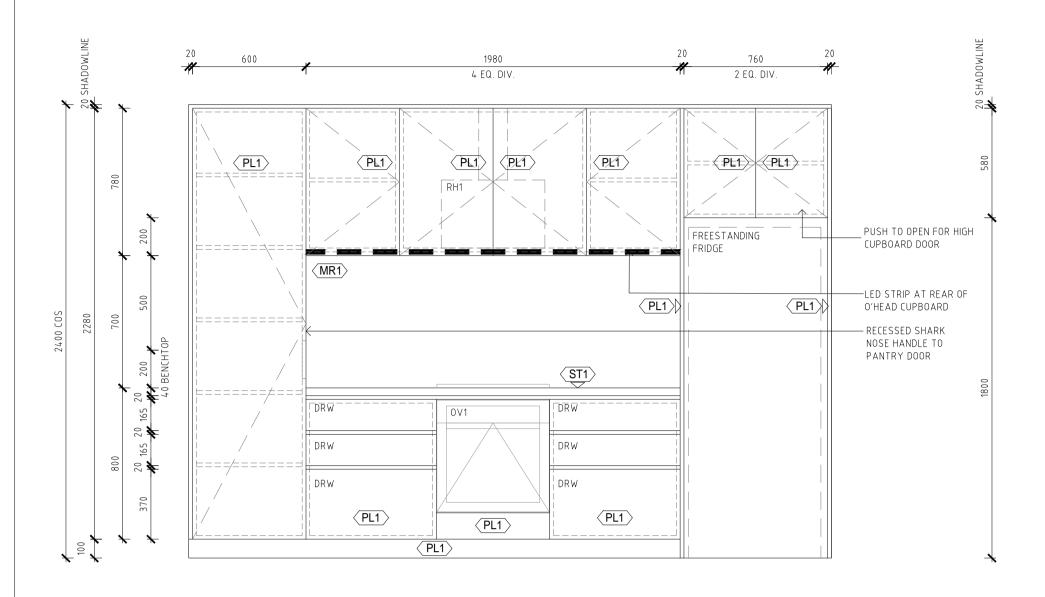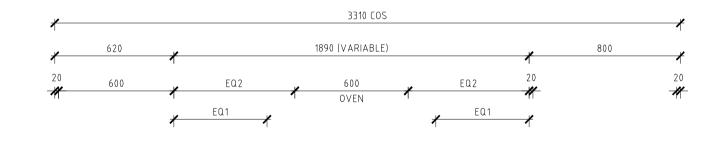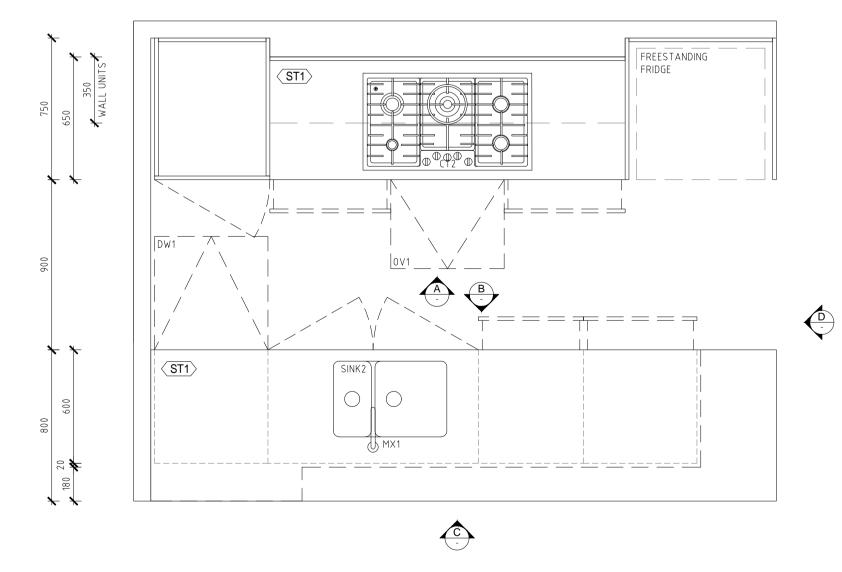Harper Building Consultants Pty Ltd











(ST1) 800 04 ELEVATION C - SCALE 1:20 @ A1

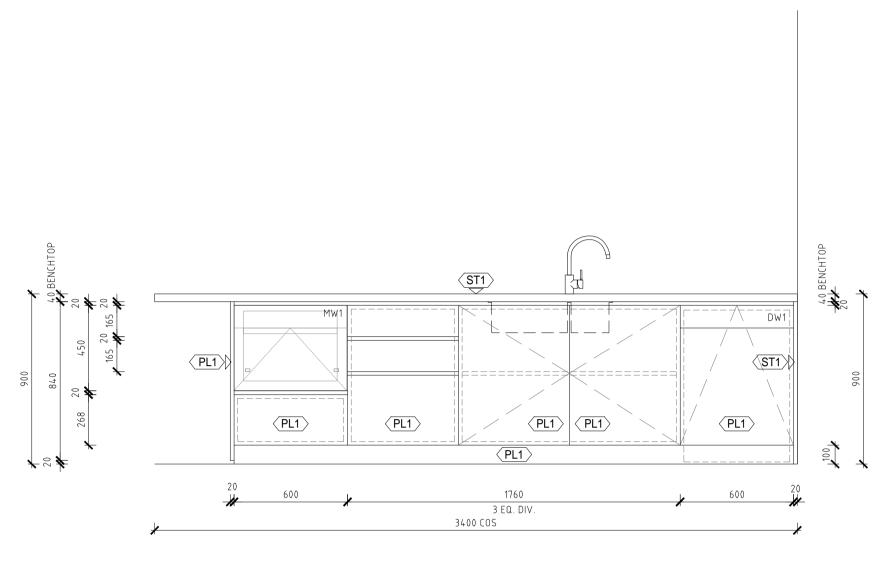01 DETAIL PLAN SCALE 1:20 @ A1




- SCALE 1:20 @ A1

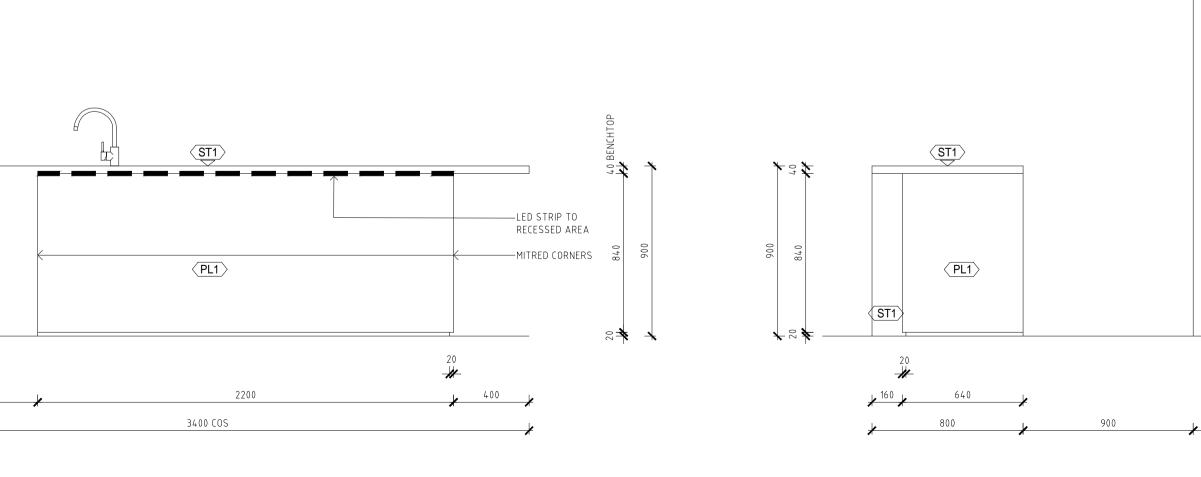


05 ELEVATION D - SCALE 1:20 @ A1

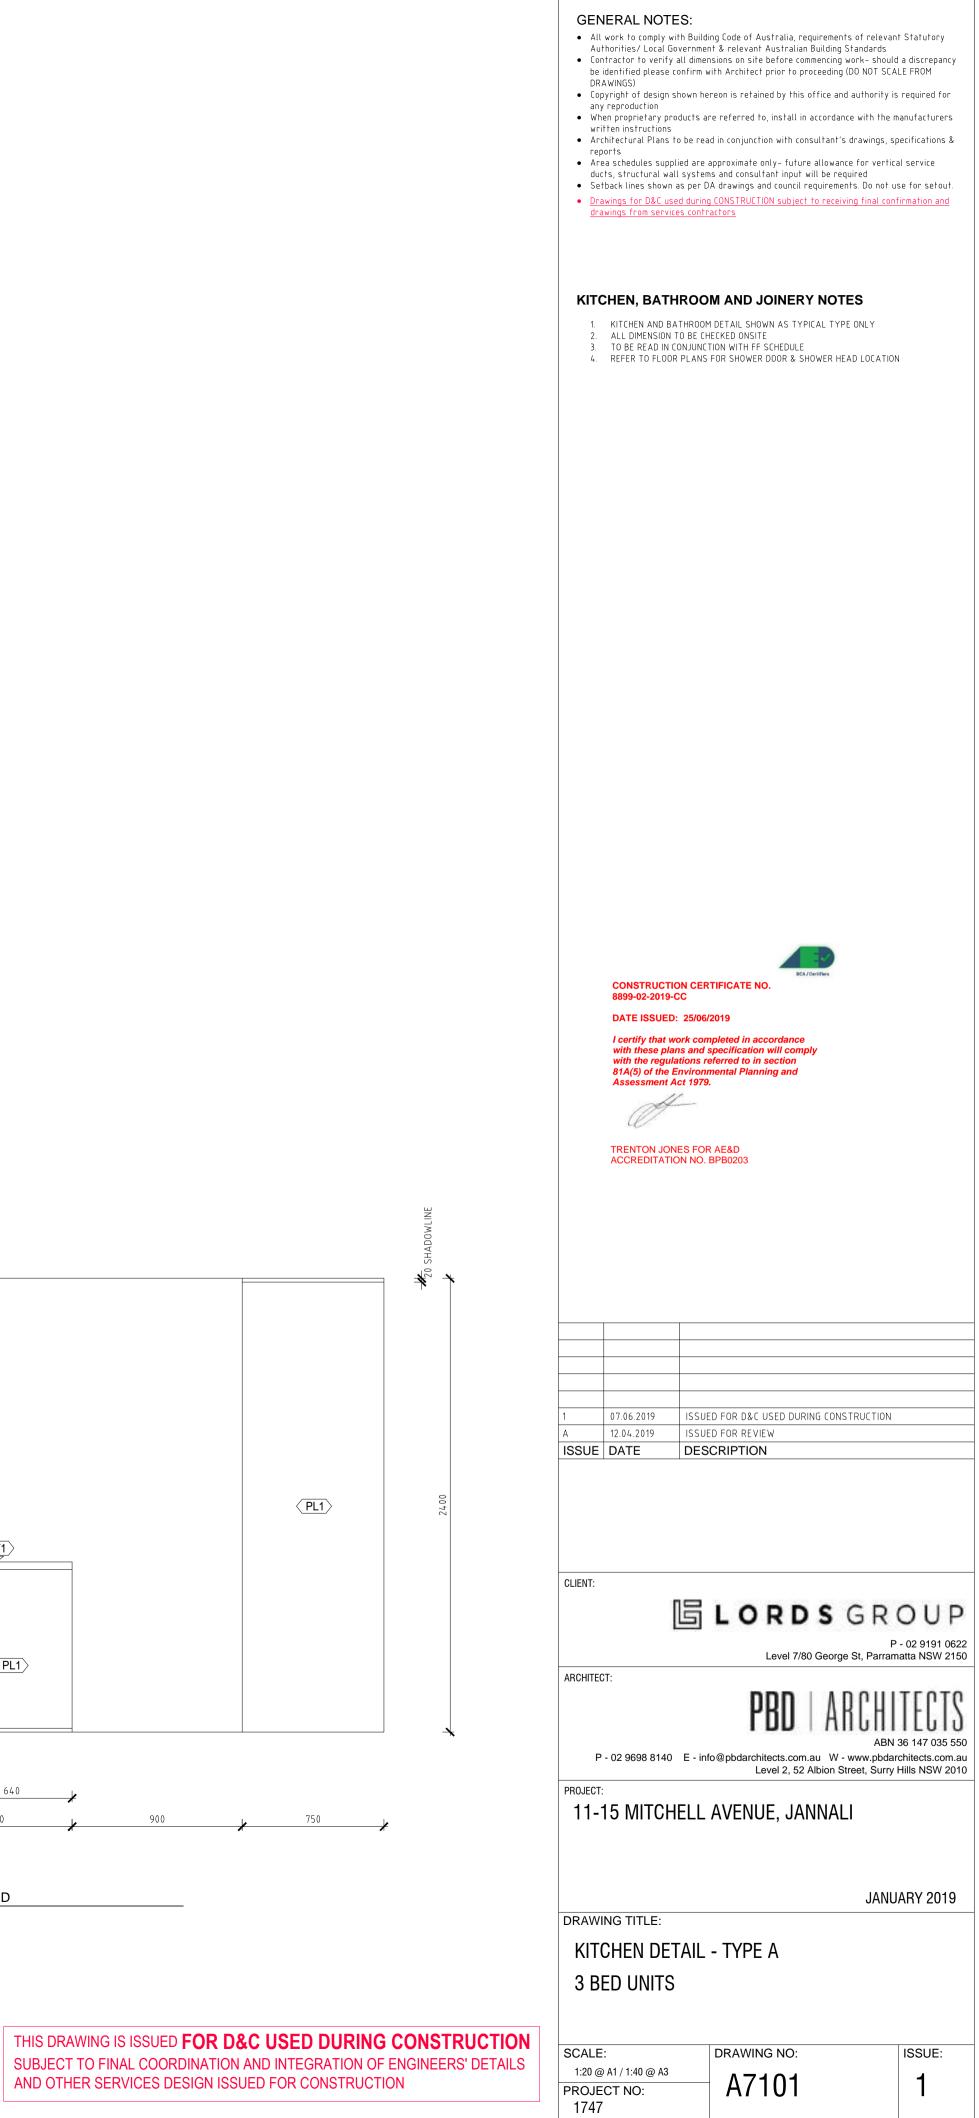
AND OTHER SERVICES DESIGN ISSUED FOR CONSTRUCTION





Harper Building Consultants Pty Ltd

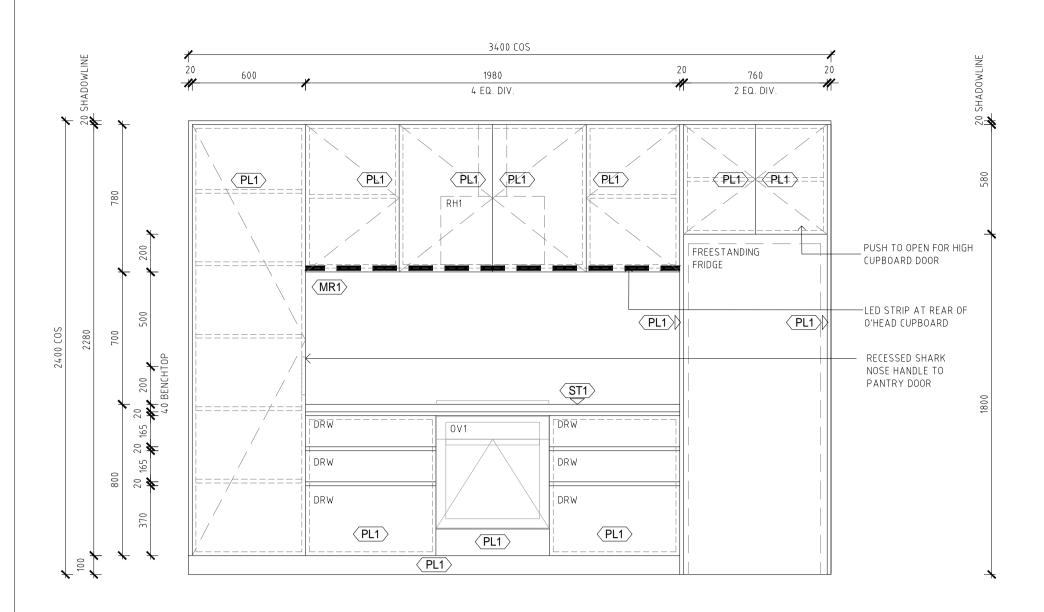


- COLE 1:20 @ A1

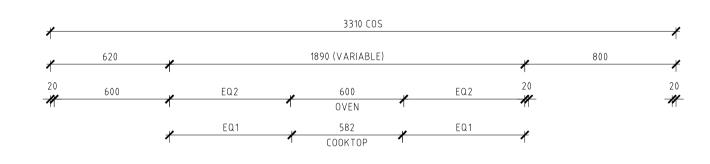

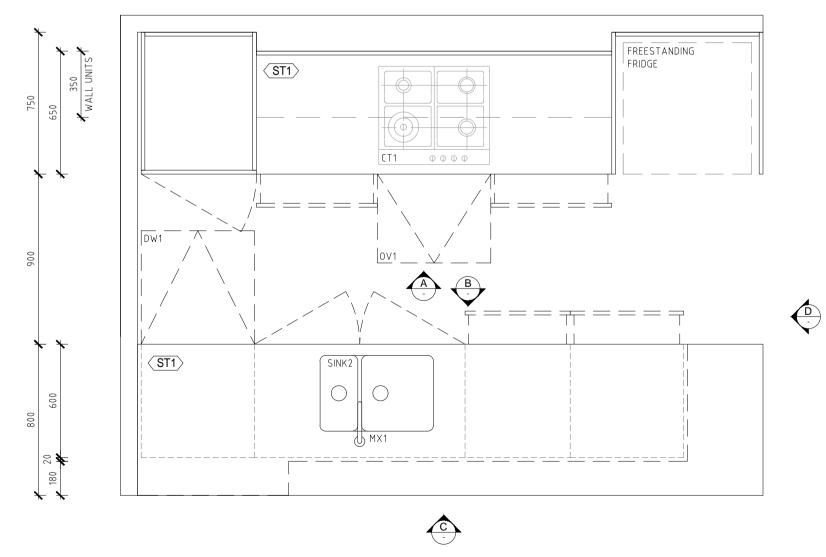


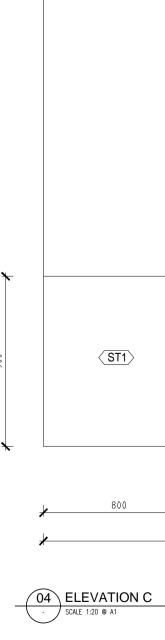

O1 DETAIL PLAN - SCALE 1:20 @ A1

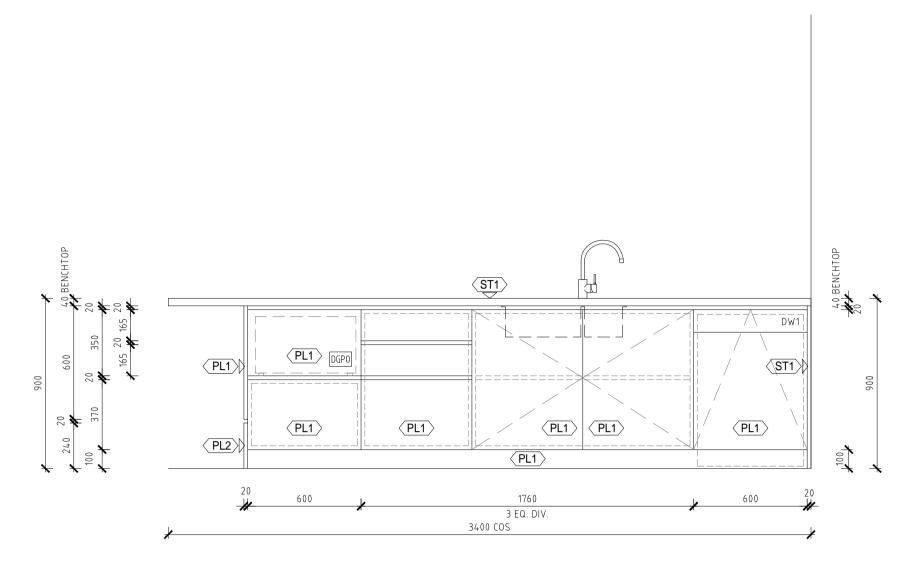




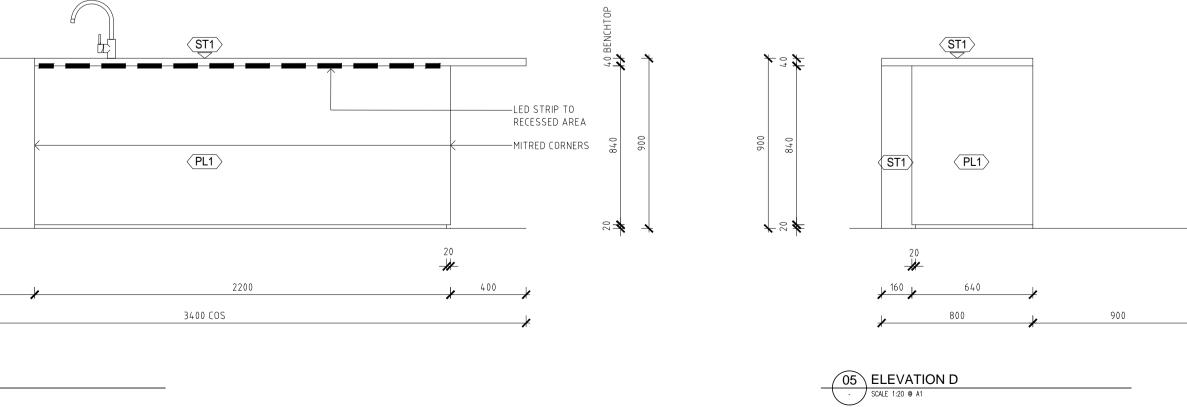



THIS DRAWING IS ISSUED **FOR D&C** SUBJECT TO FINAL COORDINATION AN AND OTHER SERVICES DESIGN ISSUE GENERAL NOTES:

		 All work to comply with Building Code of Australia, requirements of relevant Statutory Authorities/ Local Government & relevant Australian Building Standards Contractor to verify all dimensions on site before commencing work- should a discrepancy be identified please confirm with Architect prior to proceeding (D0 NOT SCALE FROM DRAWINGS) Copyright of design shown hereon is retained by this office and authority is required for any reproduction When proprietary products are referred to, install in accordance with the manufacturers written instructions Architectural Plans to be read in conjunction with consultant's drawings, specifications & reports Area schedules supplied are approximate only- future allowance for vertical service ducts, structural wall systems and consultant input will be required Setback lines shown as per DA drawings and council requirements. Do not use for setout. Drawings for D&C used during CONSTRUCTION subject to receiving final confirmation and drawings from services contractors
		 KITCHEN, BATHROOM AND JOINERY NOTES 1. KITCHEN AND BATHROOM DETAIL SHOWN AS TYPICAL TYPE ONLY 2. ALL DIMENSION TO BE CHECKED ONSITE 3. TO BE READ IN CONJUNCTION WITH FF SCHEDULE 4. REFER TO FLOOR PLANS FOR SHOWER DOOR & SHOWER HEAD LOCATION
		CONSTRUCTION CERTIFICATE NO. 8899-02-2019-CC DATE ISSUED: 25/06/2019 I certify that work completed in accordance with these plans and specification will comply with the regulations referred to in section 81A(5) of the Environmental Planning and Assessment Act 1979. TRENTON JONES FOR AE&D ACCREDITATION NO. BPB0203
	K20 SHADOWLINE	
(PL1)	2400	Image:
	*	CLIENT: E LORDSGROUP P - 02 9191 0622 Level 7/80 George St, Parramatta NSW 2150 ARCHITECT: PBD ARCHITECTS ABN 36 147 035 550 P - 02 9698 8140 E - info@pbdarchitects.com.au W - www.pbdarchitects.com.au
750	2	PROJECT: 11-15 MITCHELL AVENUE, JANNALI JANUARY 2019 DRAWING TITLE: KITCHEN DETAIL - TYPE B
C USED DURING (ND INTEGRATION OF E ED FOR CONSTRUCTION	NGINEERS' DETAILS	SCALE: 1:20 @ A1 / 1:40 @ A3 PROJECT NO: A7102 1747

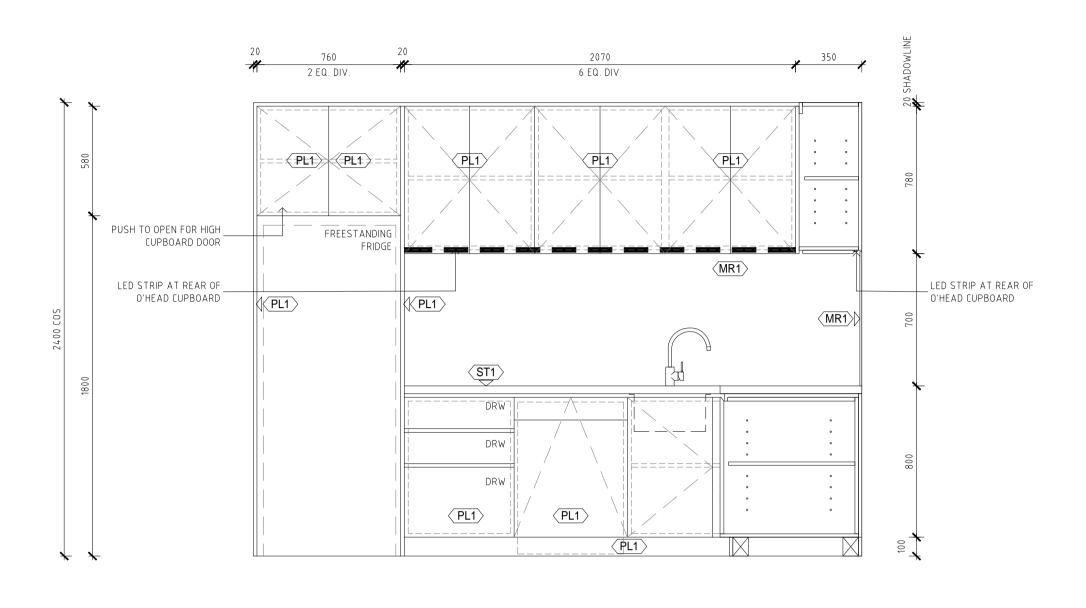




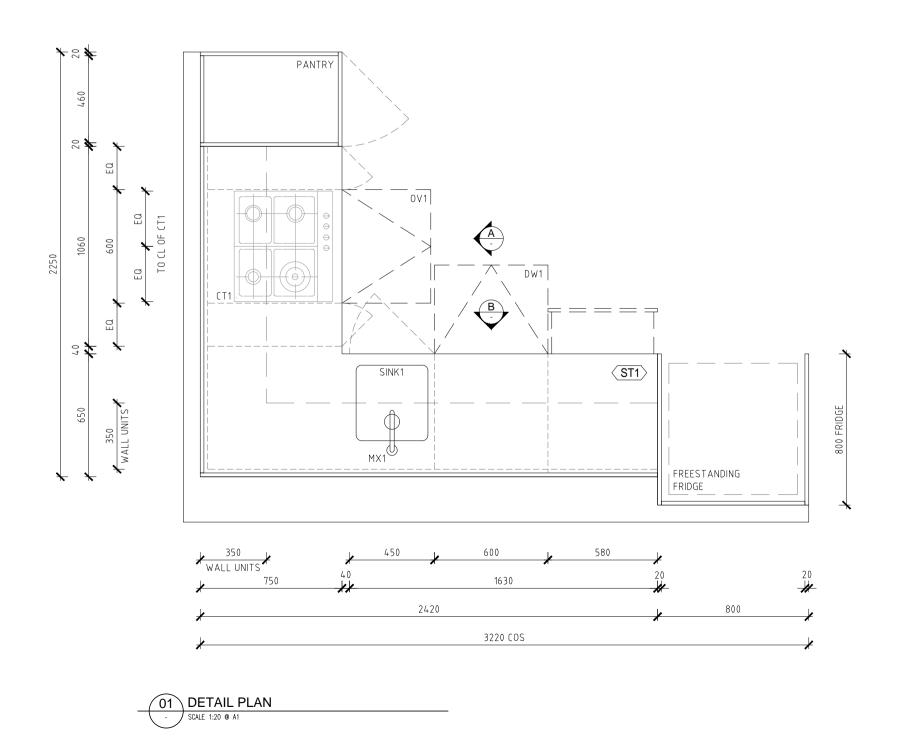


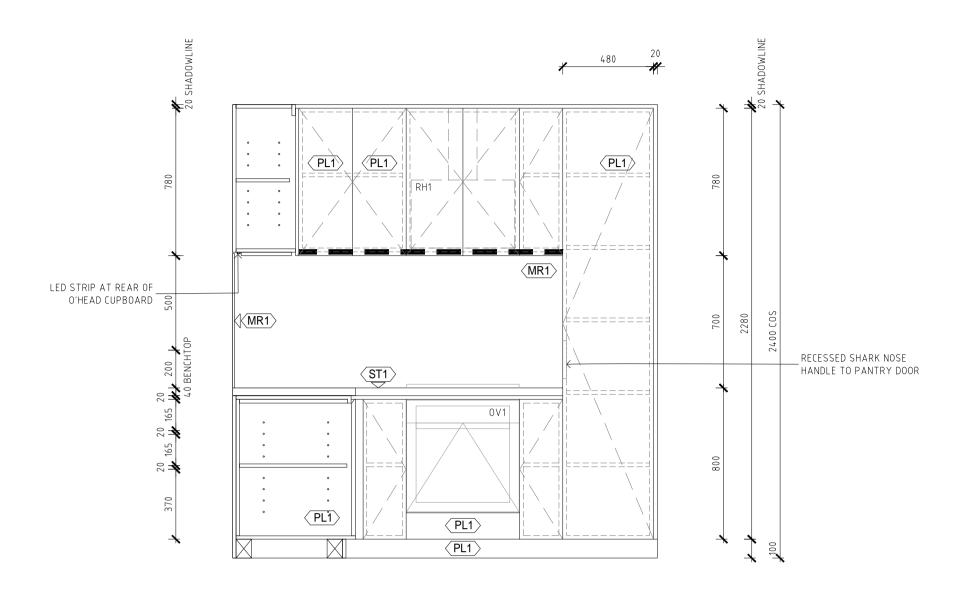




	GENERAL NOTES	:	
	Authorities/Local Gover Contractor to verify all be identified please conf DRAWINGS) Copyright of design show any reproduction When proprietary produc	Building Code of Australia, requirements rnment & relevant Australian Building St dimensions on site before commencing wo irm with Architect prior to proceeding (D wn hereon is retained by this office and a cts are referred to, install in accordance	andards ork- should a discrepancy O NOT SCALE FROM authority is required for
	reports • Area schedules supplied ducts, structural wall sy • Setback lines shown as	e read in conjunction with consultant's d are approximate only- future allowance ystems and consultant input will be requi per DA drawings and council requirement during CONSTRUCTION subject to receivin contractors	for vertical service red s. Do not use for setout.
	1. KITCHEN AND BATH	OOM AND JOINERY NOTE ROOM DETAIL SHOWN AS TYPICAL TYPE BE CHECKED ONSITE	
	3. TO BE READ IN CON	JUNCTION WITH FF SCHEDULE ANS FOR SHOWER DOOR & SHOWER HEAI	DLOCATION
	CONSTRUCTION 8899-02-2019-CC	CERTIFICATE NO.	
	with these plans with the regulation	c completed in accordance and specification will comply ns referred to in section ironmental Planning and	
	TRENTON JONES ACCREDITATION		
	1 07.06.2019 I	SSUED FOR D&C USED DURING CONST	RUCTION
		SSUED FOR REVIEW DESCRIPTION	
	CLIENT:		
		LORDS (P - 02 9191 0622 St, Parramatta NSW 2150
	ARCHITECT: P - 02 9698 8140 E	PBD AR	ABN 36 147 035 550
	PROJECT:		eet, Surry Hills NSW 2010
	DRAWING TITLE:		JANUARY 2019
	KITCHEN DETA 1 BED UNITS	NIL - TYPE C	
JCTION DETAILS	SCALE: 1:20 @ A1 / 1:40 @ A3 PROJECT NO: 1747	drawing no:	ISSUE: 1

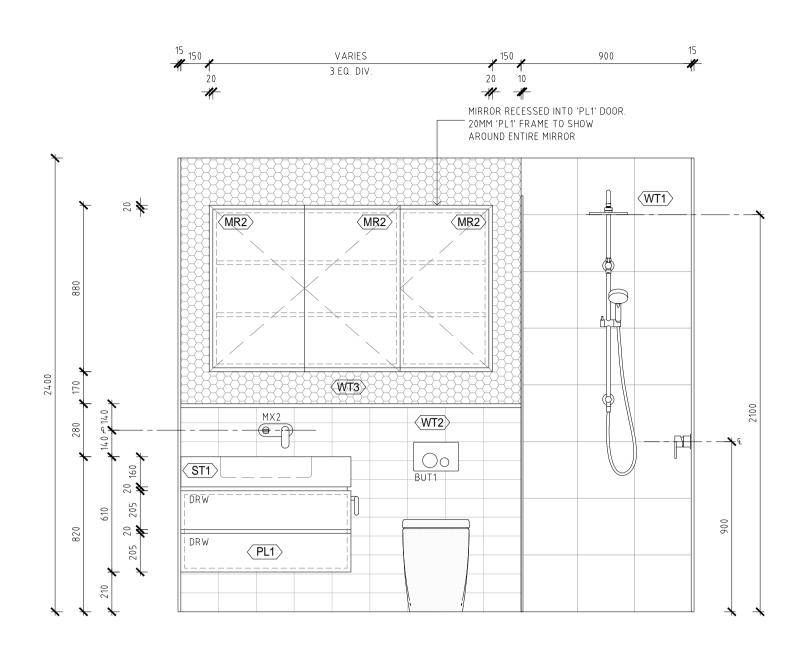


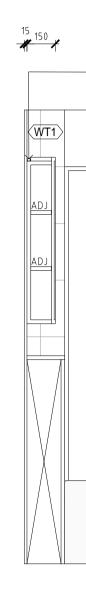


- CO2 ELEVATION A SCALE 1:20 @ A1

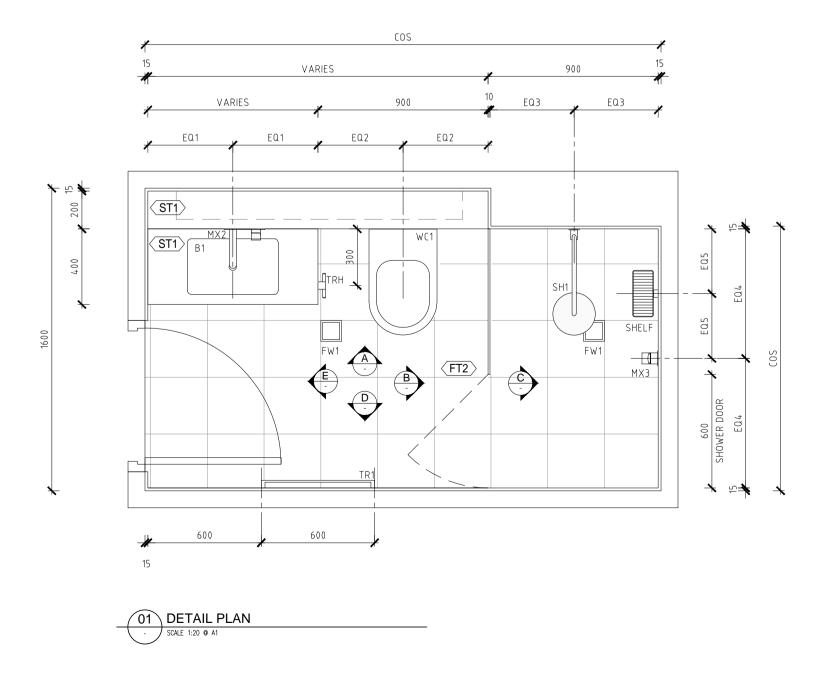


Page 1085 of 1510

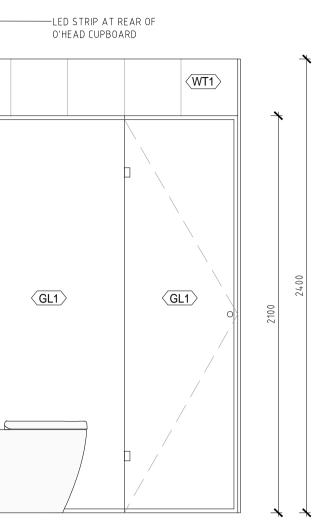


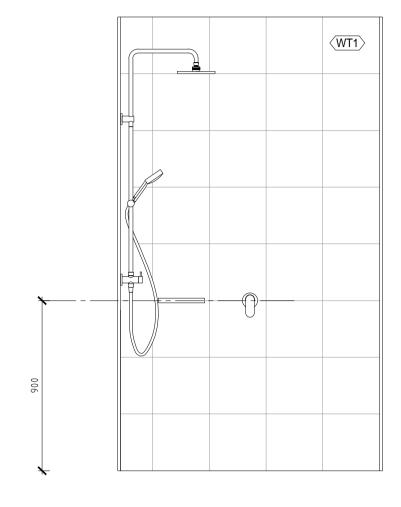

- O3 ELEVATION B SCALE 1:20 @ A1



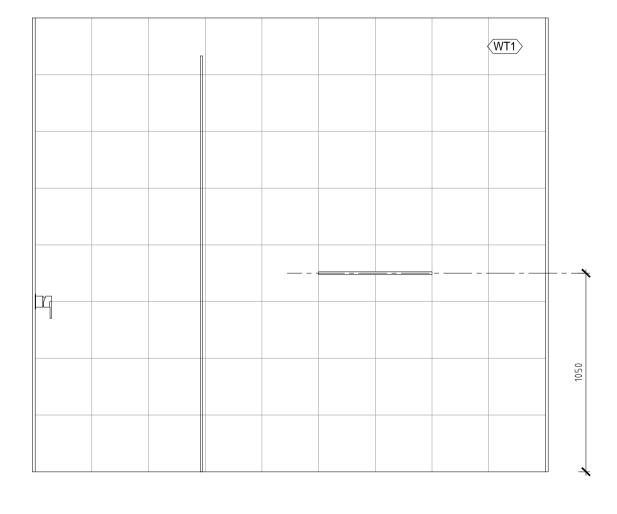

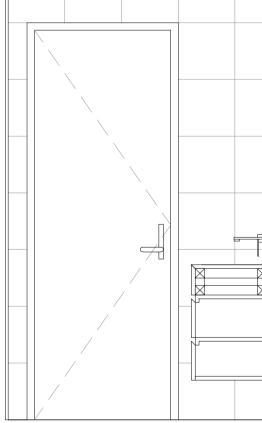


- COALE 1:20 @ A1


THIS DRAWING IS ISSUED **FOR D&C USED DURING CONSTRUCTION** SUBJECT TO FINAL COORDINATION AND INTEGRATION OF ENGINEERS' DETAILS AND OTHER SERVICES DESIGN ISSUED FOR CONSTRUCTION

O5 ELEVATION D SCALE 1:20 @ A1 GENERAL NOTES:

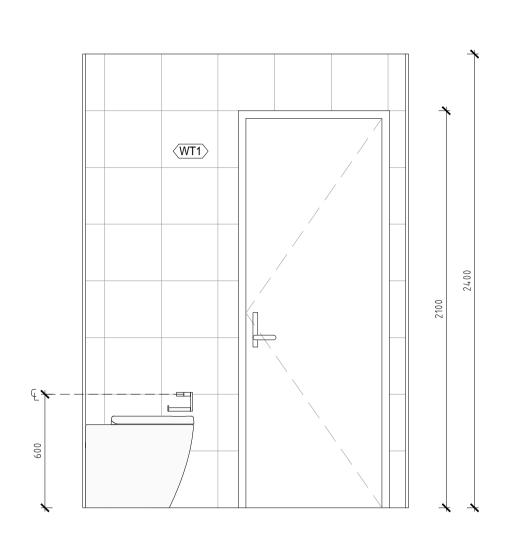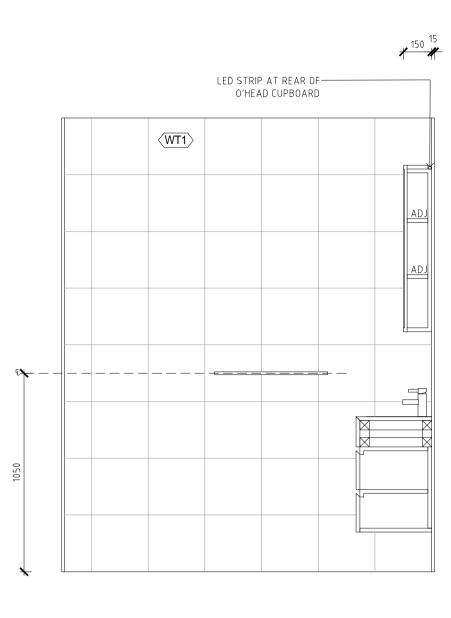WT1		

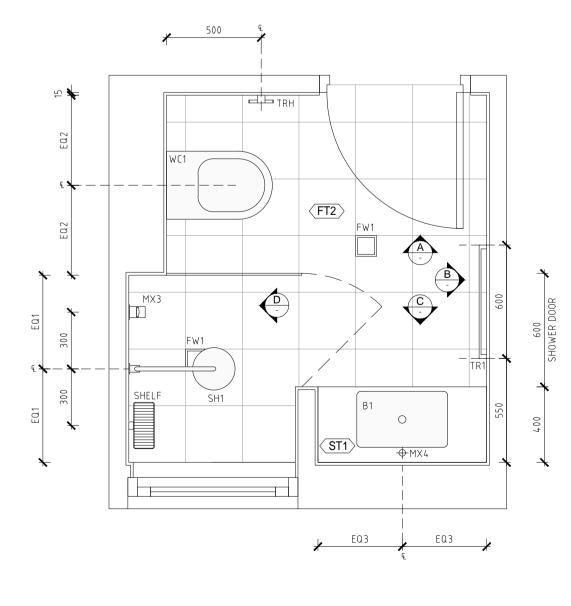
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	with the reg	lans and specification will comply ulations referred to in section e Environmental Planning and t Act 1979.	
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AISSU	ACCREDITA 07.06.2019 12.04.2019 JE DATE T:	ISSUED FOR D&C USED DURING ISSUED FOR REVIEW DESCRIPTION	SGROUP P - 02 9191 0622 George St, Parramatta NSW 2150
A ISSU CLIEN	ACCREDITA 0.07.06.2019 12.04.2019 JE DATE T: T:	ISSUED FOR D&C USED DURING ISSUED FOR REVIEW DESCRIPTION Level 7/80 G DBD	S G R O U P P - 02 9191 0622 George St, Parramatta NSW 2150 ARCHITECTS ABN 36 147 035 550 W - www.pbdarchitects.com.au
A ISSU CLIEN	ACCREDITA ACCREDITA 07.06.2019 12.04.2019 JE DATE T: T: P - 02 9698 814 ECT:	ISSUED FOR D&C USED DURING ISSUED FOR REVIEW DESCRIPTION Level 7/80 G DBD	S G R O U P P - 02 9191 0622 George St, Parramatta NSW 2150 ARCHITECTS ABN 36 147 035 550 W - www.pbdarchitects.com.au ion Street, Surry Hills NSW 2010
A ISSU CLIEN	ACCREDITA ACCREDITA 07.06.2019 12.04.2019 JE DATE T: T: P - 02 9698 814 ECT:	ISSUED FOR D&C USED DURING ISSUED FOR REVIEW DESCRIPTION Level 7/80 G DESCRIPTION	S G R O U P P - 02 9191 0622 George St, Parramatta NSW 2150 ARCHITECTS ABN 36 147 035 550 W - www.pbdarchitects.com.au ion Street, Surry Hills NSW 2010
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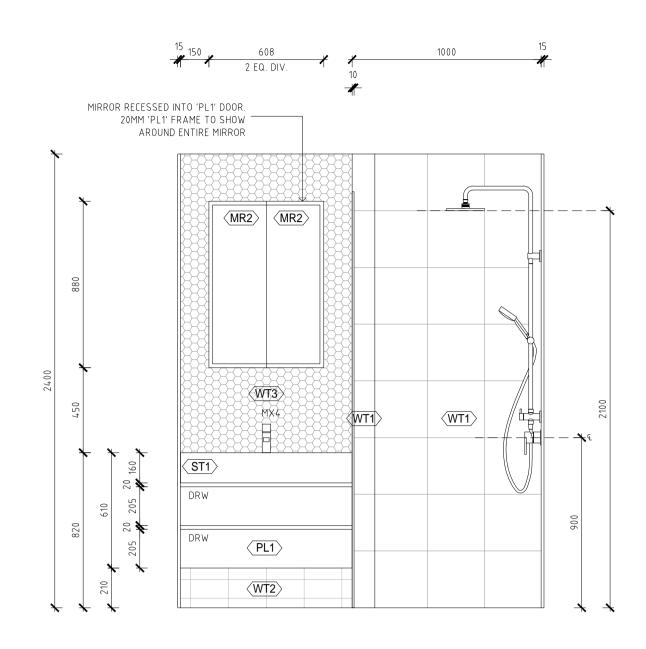









O1 DETAIL PLAN - SCALE 1:20 @ A1



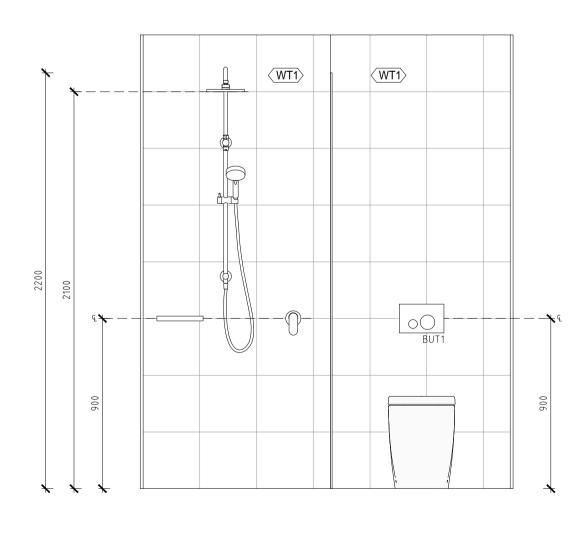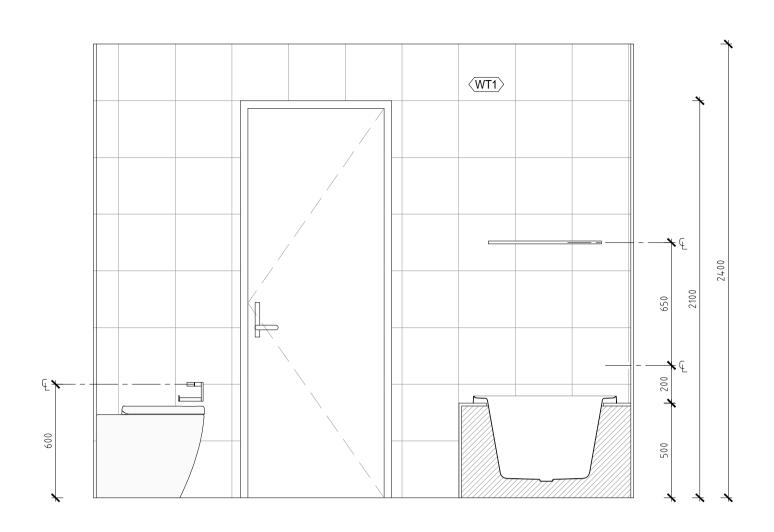
- O4 ELEVATION C SCALE 1:20 @ A1



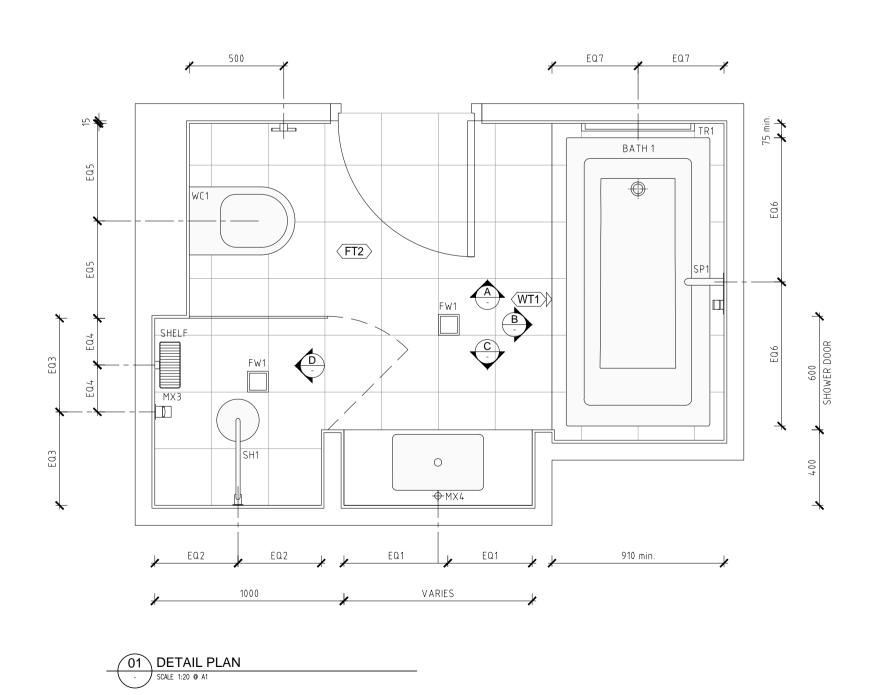
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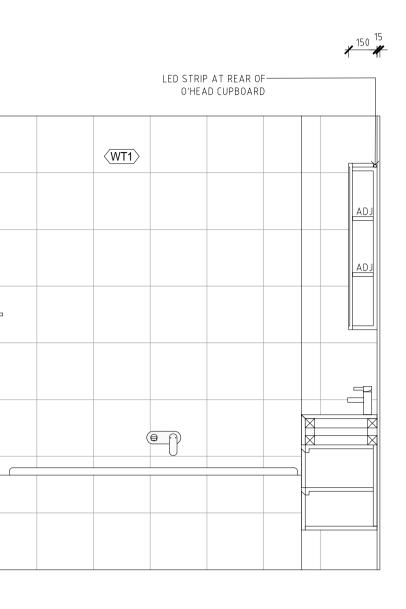
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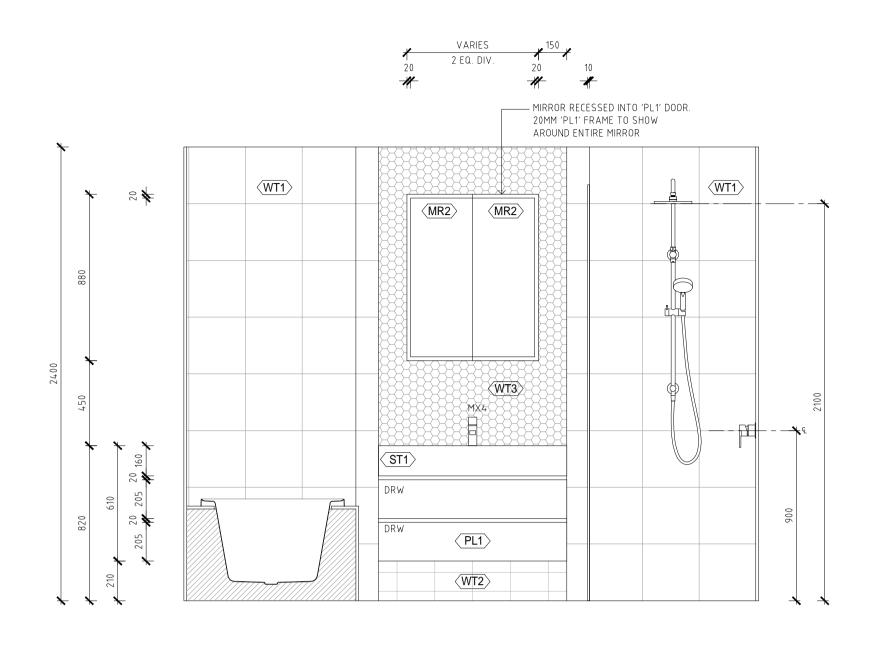
	 Authorities/ Local Governm Contractor to verify all dimbe identified please confirm DRAWINGS) Copyright of design shown any reproduction When proprietary products written instructions Architectural Plans to be reports Area schedules supplied and ducts, structural wall syst Setback lines shown as period 	ilding Code of Australia, requireme nent & relevant Australian Buildin nensions on site before commencin n with Architect prior to proceedir hereon is retained by this office a are referred to, install in accord read in conjunction with consultant re approximate only- future allow rems and consultant input will ber DA drawings and council requirem ing CONSTRUCTION subject to reco tractors	g Standards g work- should a discrepancy og (DO NOT SCALE FROM and authority is required for ance with the manufacturers t's drawings, specifications & ance for vertical service required nents. Do not use for setout.
	1. KITCHEN AND BATHRO 2. ALL DIMENSION TO BE 3. TO BE READ IN CONJUN	OM AND JOINERY NO OM DETAIL SHOWN AS TYPICAL TY CHECKED ONSITE NCTION WITH FF SCHEDULE NS FOR SHOWER DOOR & SHOWER	YPE ONLY
		BCA/Certifiers	
	with these plans an with the regulations	ERTIFICATE NO. 06/2019 ompleted in accordance d specification will comply referred to in section onmental Planning and 79.	
	A 12.04.2019 ISS	UED FOR D&C USED DURING CO UED FOR REVIEW SCRIPTION	NSTRUCTION
	CLIENT:		P - 02 9191 0622 ge St, Parramatta NSW 2150
	PROJECT:	info@pbdarchitects.com.au W	Street, Surry Hills NSW 2010
	DRAWING TITLE:	AIL - TYPE B	JANUARY 2019
UCTION DETAILS	SCALE: 1:20 @ A1 / 1:40 @ A3 PROJECT NO: 1747	drawing no:	ISSUE:













03 ELEVATION B

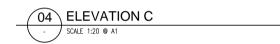

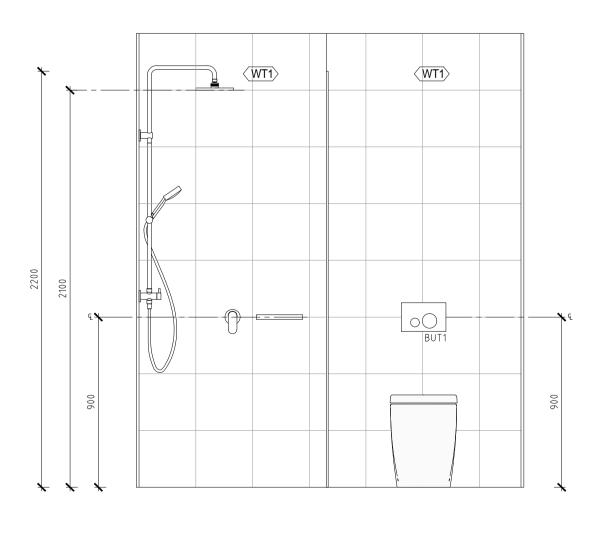

05 ELEVATION D SCALE 1:20 @ A1

AND OTHER SERVICES DESIGN ISSUED FOR CONSTRUCTION

GENERAL NOTES:

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 Contractor to verify all dimensions on site before commencing work- should a discrepancy be identified please confirm with Architect prior to proceeding (DO NOT SCALE FROM DO NUMECT)
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- Arctimetrial ar tails to be read in conjunction with consultant's drawings, spectrications a reports
 Area schedules supplied are approximate only- future allowance for vertical service ducts, structural wall systems and consultant input will be required
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- <u>Drawings for D&C used during CONSTRUCTION subject to receiving final confirmation and drawings from services contractors</u>

ΚΙΤΟ	CHEN, I	BATHR	ND JO	INERY	NOTES
4					

KITCHEN AND BATHROOM DETAIL SHOWN AS TYPICAL TYPE ONLY
 ALL DIMENSION TO BE CHECKED ONSITE
 TO BE READ IN CONJUNCTION WITH FF SCHEDULE
 REFER TO FLOOR PLANS FOR SHOWER DOOR & SHOWER HEAD LOCATION

	8899-02-2019- DATE ISSUED I certify that with these play with the regul 81A(5) of the l Assessment A	: 25/06/2019 rork completed in accordance ns and specification will comply ations referred to in section Environmental Planning and
	ACCREDITATI	ON NO. BPB0203
SSUE	07.06.2019 12.04.2019 DATE	ISSUED FOR D&C USED DURING CONSTRUCTION ISSUED FOR REVIEW DESCRIPTION
CLIENT:		LORDS GROUP P - 02 9191 0622 Level 7/80 George St, Parramatta NSW 2150

ARCHITECT:

PROJECT:

DRAWING TITLE:


ABN 36 147 035 550 P - 02 9698 8140 E - info@pbdarchitects.com.au W - www.pbdarchitects.com.au Level 2, 52 Albion Street, Surry Hills NSW 2010


11-15 MITCHELL AVENUE, JANNALI

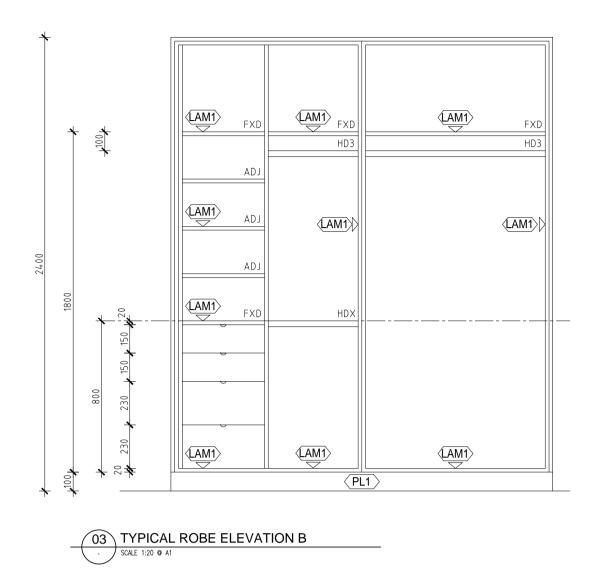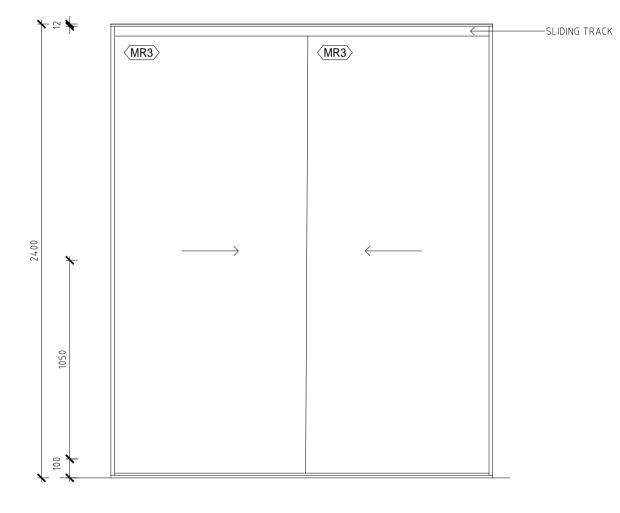JANUARY 2019

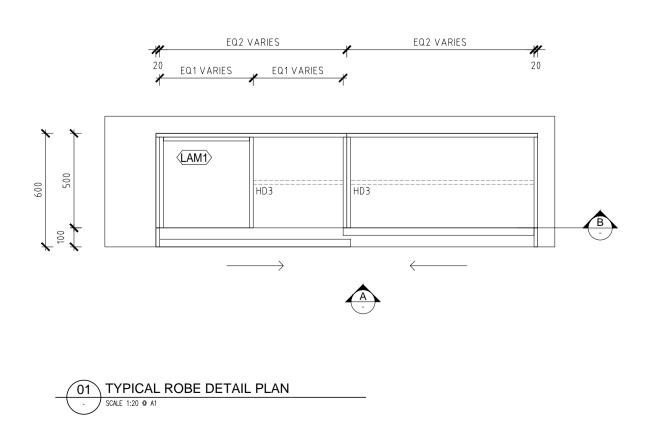
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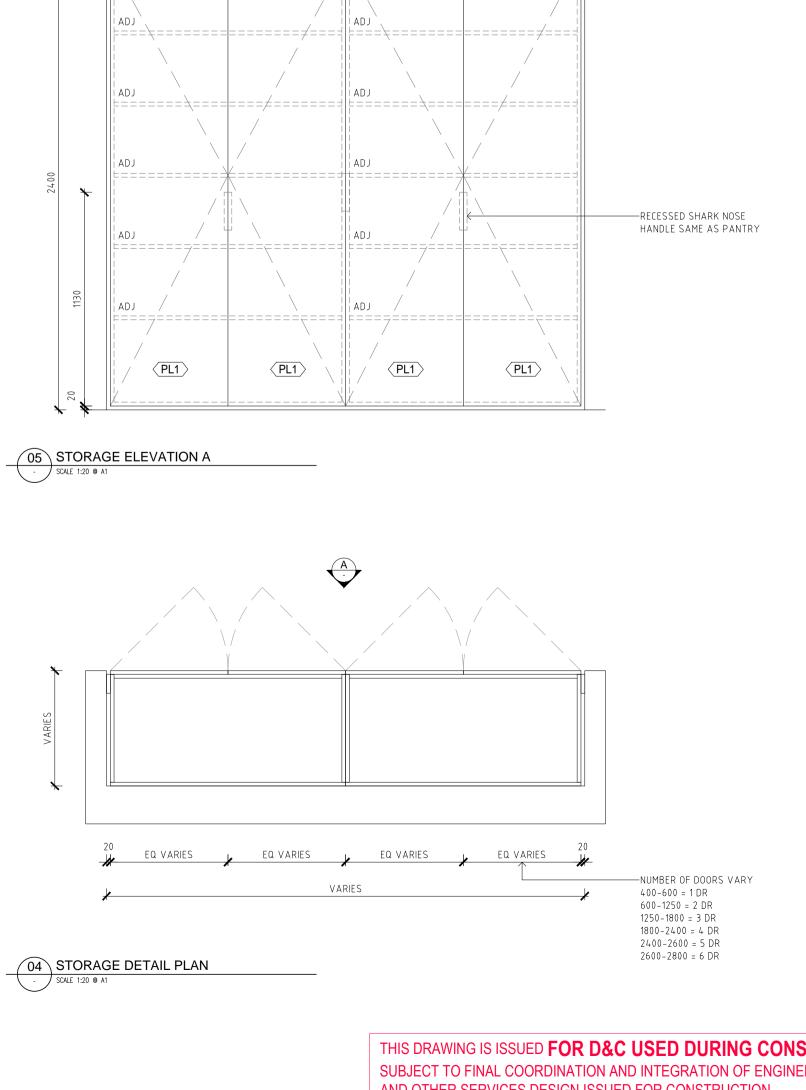
SCALE:	DRAWING NO:	ISSUE:
1:20 @ A1 / 1:40 @ A3	47000	-4
PROJECT NO:	A7203	
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- COLONIAL ROBE ELEVATION A SCALE 1:20 @ A1



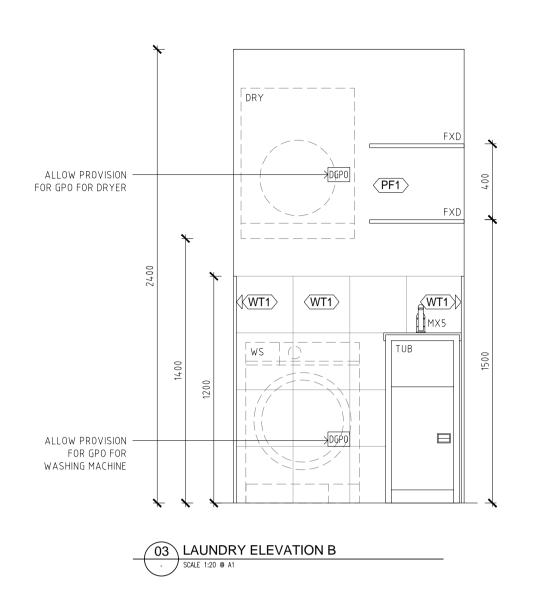


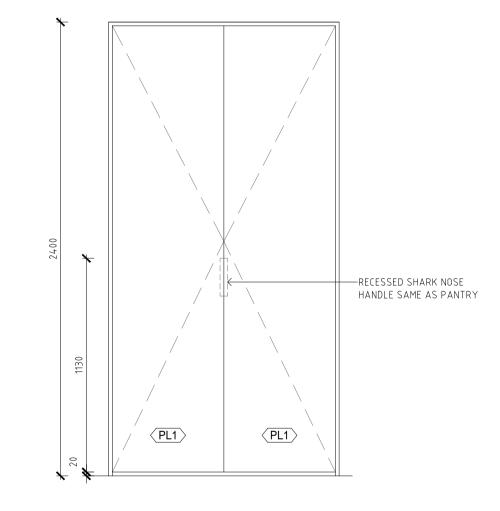
•	Authorities/ Local Gover Contractor to verify all o	: Building Code of Australia, requirem rnment & relevant Australian Buildi dimensions on site before commenci irm with Architect prior to proceed	ng Standards ng work- should a discrepancy
•	any reproduction	vn hereon is retained by this office tts are referred to, install in accor	
•	reports Area schedules supplied ducts, structural wall sy Setback lines shown as p	e read in conjunction with consultar are approximate only- future allov rstems and consultant input will be ber DA drawings and council require luring CONSTRUCTION subject to re- contractors	vance for vertical service required ments. Do not use for setout.
	 KITCHEN AND BATHF ALL DIMENSION TO E 		
		JUNCTION WITH FF SCHEDULE ANS FOR SHOWER DOOR & SHOWER	HEAD LOCATION
	CONSTRUCTION 8899-02-2019-CC DATE ISSUED: 25	CERTIFICATE NO.	
	l certify that work with these plans a with the regulation	completed in accordance and specification will comply ns referred to in section	
	Assessment Act	ironmental Planning and 1979. –	
	TRENTON JONES		
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ISSU	JE DATE D	DESCRIPTION	
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ARCHI	TECT: P - 02 9698 8140 E :CT:	Level 7/80 Gec PBD / / - info@pbdarchitects.com.au	P - 02 9191 0622 orge St, Parramatta NSW 2150 ABN 36 147 035 550 V - www.pbdarchitects.com.au o Street, Surry Hills NSW 2010
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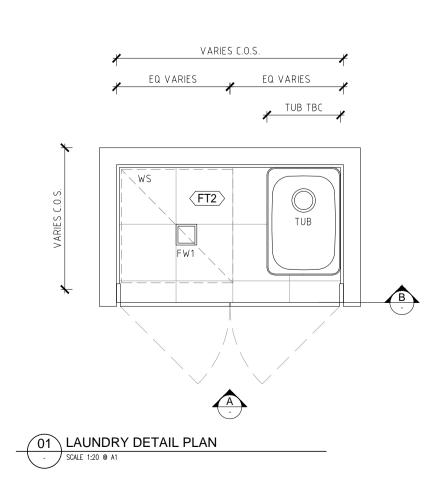
400-600 = 1 DR 600-1250 = 2 DR 1250-1800 = 3 DR 1800-2400 = 4 DR 2400-2600 = 5 DR 2600-2800 = 6 DR

AND OTHER SERVICES DESIGN ISSUED FOR CONSTRUCTION





- O2 - SCALE 1:20 @ A1



THIS DRAWING IS ISSUED **FOR D&C USED DURING CONSTRU** SUBJECT TO FINAL COORDINATION AND INTEGRATION OF ENGINEERS' AND OTHER SERVICES DESIGN ISSUED FOR CONSTRUCTION

	Authorities/ Local Governm Contractor to verify all dim be identified please confirm DRAWINGS) Copyright of design shown th any reproduction When proprietary products written instructions Architectural Plans to be re reports Area schedules supplied are ducts, structural wall syste Setback lines shown as per	ding Code of Australia, requirements o ent & relevant Australian Building Sta ensions on site before commencing wor with Architect prior to proceeding (DC mereon is retained by this office and ar are referred to, install in accordance ead in conjunction with consultant's dr e approximate only- future allowance ems and consultant input will be requir DA drawings and council requirements an <u>g CONSTRUCTION subject to receiving</u> tractors	indards 'k- should a discrepancy DOT SCALE FROM withority is required for with the manufacturers awings, specifications & for vertical service red . Do not use for setout.
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	with these plans and with the regulations	mpleted in accordance I specification will comply referred to in section mental Planning and 9.	
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	CLIENT:		P - 02 9191 0622
	PROJECT:	PBD AR	ABN 36 147 035 550
	DRAWING TITLE:	RY DETAILS	JANUARY 2019
JCTION DETAILS	SCALE: 1:20 @ A1 / 1:40 @ A3 PROJECT NO: 1747	drawing no:	ISSUE: 1

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Floor Finishes Living, Kitchen, Dining Floor Tile Madera FT1 Tan Skheme Nathan Danks 02 8755 2300 Bathrooms, Ensuites and Laundrys Porcelain Tiles Core Dims: 300x300 FT2 Cool Silver Skheme Nathan Danks 02 8755 2300 Bedrooms Carpet Toulon 30 CPT1 Biscotti Normal Ellison Carpets	ISSUE
Living, Kitchen, Dining Floor Tile Madera FT1 Tan Skheme Nathan Danks 02 8755 2300 Bathrooms, Ensuites and Laundrys Porcelain Tiles Core Dims: 300x300 FT2 Cool Silver Skheme Nathan Danks 02 8755 2300 Bedrooms Carpet Toulon 30 CPT1 Biscotti Normal Ellison Carpets	
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Project: 11-15 Mitchell Ave, Jannali

INTERIOR FINISHES SCHEDULE

NOT FOR CONSTRUCTION

ISSUE REVISION	DATE	AMENDMENT/ DESCRIPTION
1	26/04/2018	Preliminary Issue
2	7/05/2018	Revised Balcony Tile Specification
3	17/05/2018	Updated Specification
A	12/04/2019	Issued for review
В	7/06/2019	Issued for D&C used during construction

NOTE:

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- 2. Refer to service consultants specifications for all services layout & specifications
- 3. Refer to Door / Window Schedule for Hardware
- 4. Installation & Construction as per relevant BCA & Australian Standards
- 5. Light / Dark Scheme to be coordinated by the builder



CONSTRUCTION CERTIFICATE NO. 8899-02-2019-CC

DATE ISSUED: 25/06/2019

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TRENTON JONES FOR AE&D ACCREDITATION NO. BPB0203

LOCATION	ITEM	MATERIAL/ DESCRIPTION	CODE	COLOUR/ RANGE	Cost	SUPPLIER	IMAGE	ISSUE
Living, Kitchen, Dining	Plasterboard	Dulux Wash n Wear Satin Finish	PF1	Snowy Mountain Half		Dulux www.dulux.com.au		1
Bathrooms and Ensuites	Wall Tile	Core Matt Finish Dims: 300x300	WT1	Cool Silver		Skheme Nathan Danks 02 8755 2300		1
Bathroom	Featured Tile	Core Matt Finish Dims: 100x200		Cool Silver		Skheme Nathan Danks 02 8755 2300		1
Bathroom	Featured Tile	Savoy	WT3	Grey Gloss		Skheme Nathan Danks 02 8755 2300		1

Project: 11-15 Mitchell Ave, INTERIOR FINISHES SCHED NOT FOR CONSTRUCTION			BCA / Certifier
ISSUE REVISION	DATE	AMENDMENT/ DESCRIPTION	CONSTRUCTION CERTIFICATE NO. 8899-02-2019-CC
1 2 2	26/04/2018 7/05/2018 17/05/2018	Preliminary Issue Revised Balcony Tile Specification	DATE ISSUED: 25/06/2019
A B	12/04/2019 7/06/2019	Updated Specification Issued for review Issued for D&C used during construction	I certify that work completed in accordance with these plans and specification will comply
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TRENTON JONES FOR AE&D ACCREDITATION NO. BPB0203

LOCATION	ITEM	MATERIAL/ DESCRIPTION	CODE	COLOUR/ RANGE	Cost	SUPPLIER	IMAGE	ISSUE
Apartment Entry Door	Paint	Dulux Wash n Wear Satin Finish	DF1	Snowy Mountain Half		Dulux www.dulux.com.au		1
Internal Doors	Paint	Dulux Wash n Wear Semi Gloss	DF2	Natural White		Dulux www.dulux.com.au		1
Skirting Board	Timber Skirting	Timber Profile Code: SK01 Dims: 90 x 12mm	SK1	Paint Finish to match PF1		Intrim Mouldings	F	1
Ceiling Finishes								
Apartment Ceiling - general area Lobby Ceiling	Plasterboard	Rondo P50 stopping bead to ceiling and wall junction. Paint finish	PF2	Ultra White		Dulux www.dulux.com.au		1

Mitchell Ave Developments P/L vs Forte Sydney Constructions P/L Report issued: 25 February 2022



CONSTRUCTION CERTIFICATE NO. 8899-02-2019-CC

Project: 11-15 Mitchell Ave, Jannali INTERIOR FINISHES SCHEDULE

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LOCATION	ITEM	MATERIAL/ DESCRIPTION	CODE	COLOUR/ RANGE	Cost	SUPPLIER	IMAGE	ISSUE
Apartment Ceiling - wet areas Accessible Bathroom	Moisture resistant plasterboard	Square set to junction with wall Paint finish	PF2	Ultra White		Dulux www.dulux.com.au		1
Bulkheads Over Kitchens	Plasterboard	Rondo P50 stopping bead to ceiling and wall junction. Paint finish	PF2	Ultra White		Dulux www.dulux.com.au		1
Joinery Finishes								
All Kitchens, Bathrooms and Laundries	Benchtop	Code: 4001		Fresh Concrete		Caesarstone Jason Bockett 0438483496		3
Kitchen	Splashback	Grey reflections Code: DG4265	MR1			Decoglaze www.decoglaze.com (02) 9624 7100		1

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Project: 11-15 Mitchell Ave, Jannali INTERIOR FINISHES SCHEDULE

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TRENTON JONES FOR AE&D ACCREDITATION NO. BPB0203

LOCATION	ITEM	MATERIAL/ DESCRIPTION	CODE	COLOUR/ RANGE	Cost	SUPPLIER	IMAGE	ISSUE
All Kitchens and Bathrooms	Island bench Joinery Doors Panels Vanity Cupboards Other misc.	30% Gloss 2 Pac polyurethane	PL1	Dieskau		Dulux www.dulux.com.au		1
All Kitchens, Vanities, Wardrobes and Storage	Joinery carcass and all shelves	Grey laminate 18mm with matching ABS edging	LAM1	Equal to Laminex 'Fox'		Laminex www.laminex.com		1
All Kitchen and Vanities	Shadowline detail	Laminate 18mm board	LAM3	Equal to Laminex 'White'		Dulux www.dulux.com.au		1
All Bathrooms	Bathroom Cabinets	Silverbacked mirror with 15 x15mm polyurethane box section - to match PL1	MR2			Decoglaze www.decoglaze.com (02) 9624 7100		1
All Bathrooms and Ensuites	Shower Screens	6mm Semi-Frameless Clear Glass with Chrome frame	GL1					1

Project: 11-15 Mitchell Ave, Jannali INTERIOR FINISHES SCHEDULE

NOT FOR CONSTRUCTION

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LOCATION	ITEM	MATERIAL/ DESCRIPTION	CODE	COLOUR/ RANGE	Cost	SUPPLIER	IMAGE	ISSUE
All Bedrooms	Robe mirror	TBC	MR3			Builder's Preferred		
								2



CONSTRUCTION CERTIFICATE NO. 8899-02-2019-CC

DATE ISSUED: 25/06/2019

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TRENTON JONES FOR AE&D ACCREDITATION NO. BPB0203

Project: 11-15 Mitchell Ave, Jannali FIXTURES, FITTINGS AND HARDWARE

ISSUE REVISION	DATE	AMENDMENT/ DESCRIPTION
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CONSTRUCTION CERTIFICATE NO. 8899-02-2019-CC

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BCA/Certifiers



TRENTON JONES FOR AE&D

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- 5. Light / Dark Scheme to be coordinated by the builder

5. Light / Da	ark Scheme to be coordinated b	by the builder		TRENTON JONES FOR AE&D ACCREDITATION NO. BPB0203						
LOCATION	ITEM	MATERIAL/ DESCRIPTION	CODE	COLOUR/ RANGE	NOTES	SUPPLIER	IMAGE	BASIX PROV	BASIX REQ.	ISSUE
Kitchen Fixtures, Fittings and Appliances	Mixer	PARISI Envy Arch Sink Mixer Code: PP071HR.131	MX1	Brushed Chrome		Harvey Norman Nicole Mensforth 0400 981 608 nicole.mensforth@au.harveynorman.com		6 Water	4 Water	1
	Single Sink	Lago Single Bowl Undermount Sink NTH Code: LG100UXC	SINK1	Stainless Steel		Harvey Norman Nicole Mensforth 0400 981 608 nicole.mensforth@au.harveynorman.com				1
	Double Sink	Lago Project 660mm 1&1/3 Bowl U/Mount Sink NTH Code: LG180UXC	SINK2	Stainless Steel		Harvey Norman Nicole Mensforth 0400 981 608 nicole.mensforth@au.harveynorman.com				1
	Cutlery Insert	Hafele or similar to suit drawer size	-			Builder's Preferred				1
	Oven	AEG 60cm Oven Code: BEE455010M-C	OV1	Stainless Steel and Black Glass		Harvey Norman Nicole Mensforth 0400 981 608 nicole.mensforth@au.harveynorman.com				1
	Cooktop (4 burner)	AEG 60cm Stainless Steel Gas Cooktop Code: HG60FXM	CT1	Stainless Steel		Harvey Norman Nicole Mensforth 0400 981 608 nicole.mensforth@au.harveynorman.com	0			1



CONSTRUCTION CERTIFICATE NO. 8899-02-2019-CC

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TRENTON JONES FOR AE&D ACCREDITATION NO. BPB0203

BASIX BASIX LOCATION ITEM MATERIAL/ DESCRIPTION CODE COLOUR/ RANGE NOTES SUPPLIER IMAGE ISSUE REQ. PROV Stainless Steel Cooktop (5 burner) AEG 75cm Stainless Steel Gas Cooktop CT2 Harvey Norman Code: HG75FXA Nicole Mensforth 0400 981 608 nicole.mensforth@au.harveynorman.com 46cm Built-In Microwave / Grill MW1 Stainless Steel and Black Glass Harvey Norman Microwave 1 Code: MBE2658DM Nicole Mensforth 0400 981 608 nicole.mensforth@au.harveynorman.com Rangehood AEG 54cm Integrated Rangehood RH1 Stainless Steel Harvey Norman 1 Code: DGE5660HM Nicole Mensforth 0400 981 608 nicole.mensforth@au.harveynorman.com AEG 77cm Integrated Rangehood Rangehood RH2 Stainless Steel Harvey Norman 1 Code: DGE5860HM Nicole Mensforth 0400 981 608 nicole.mensforth@au.harveynorman.com AEG Semi Integrated Dishwasher Stainless Steel / Joinery Panel Harvey Norman Semi-Integrated Dishwasher DW1 1 Code: FEE83700PM Nicole Mensforth -0400 981 608 nicole.mensforth@au.harveynorman.com 4.5 Water 2 Water 3.5 Energy 2.5 Energy throoms & Ensu

NOTE:

Project: 11-15 Mitchell Ave, Jannali

NOT FOR CONSTRUCTION

ISSUE REVISION

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FIXTURES, FITTINGS AND HARDWARE

1. Read this schedule in conjunction with architectural documentation, DA Consent & Conditions

AMENDMENT/ DESCRIPTION

Issued for D&C used during construction

Preliminary Issue

Issued for review

- 2. Refer to service consultants specifications for all services layout & specifications
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- 5. Light / Dark Scheme to be coordinated by the builder

DATE

26/04/2018

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7/06/2019

Project: 11-15 Mitchell Ave, Jannali FIXTURES, FITTINGS AND HARDWARE

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BCA/Cartifiers



TRENTON JONES FOR AE&D

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	-			ACCREDITATION NO. BPB0203						
LOCATION	ITEM	MATERIAL/ DESCRIPTION	CODE	COLOUR/ RANGE	NOTES	SUPPLIER	IMAGE	BASIX PROV	BASIX REQ.	ISSUE
	WC Pan & Seat	PARISI Linfa W/Faced Pan w/- Linfa SC Seat Code: PN770TC	WC1	White Ceramic		Harvey Norman Nicole Mensforth 0400 981 608 nicole.mensforth@au.harveynorman.com				1
	Undermounted Basin / Benchmount	PARISI Box Undercounter Basin Code: AC270	В1	White Ceramic		Harvey Norman Nicole Mensforth 0400 981 608 nicole.mensforth@au.harveynorman.com	NT -			1
	Basin Tapset (wall mounted)	Parisi Elli Wall Mixer Eliptical Plate w/- 160mm Spout Code: PE012E160.31	MX2	Brushed Chrome		Harvey Norman Nicole Mensforth 0400 981 608 nicole.mensforth@au.harveynorman.com		6 Water	5 Water	1
	Basin Mixer (Deck mounted)	Parisi Elli Basin Mixer Code: PE.01-1H		Brushed Chrome			Ĩ	6 Water	5 Water	A
	Shower Head	Parisi Envy Shower Column w/ Sliding Rail (BRUSHED CHROME) Code: PP.08-D2W.31	SH1	Brushed Chrome		Harvey Norman Nicole Mensforth 0400 981 608 nicole.mensforth@au.harveynorman.com	4	3 Water	3 Water	1



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Project: 11-15 Mitchell Ave, Jannali

NOT FOR CONSTRUCTION

ISSUE REVISION

FIXTURES, FITTINGS AND HARDWARE

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LOCATION	ITEM	MATERIAL/ DESCRIPTION	CODE	COLOUR/ RANGE	NOTES	SUPPLIER	IMAGE	BASIX PROV	BASIX REQ.	ISSUE
	Shower Wall Mixer	Parisi Elli Shower/Bath Mixer Complete Code: PE05.31	MX3	Brushed Chrome		Harvey Norman Nicole Mensforth 0400 981 608 nicole.mensforth@au.harveynorman.com	P			1
	Wall Mixer	Parisi Elli Wall Mixer Eliptical Plate w/- 220mm Spout Code: PE012E220.31	SP1	Brushed Chrome		Harvey Norman Nicole Mensforth 0400 981 608 nicole.mensforth@au.harveynorman.com	-7	6 Water	5 Water	1
	Bath	Newbury 1525mm Island Bath Dims: 1525x760x456	BATH 1	White Acrylic		Harvey Norman Nicole Mensforth 0400 981 608 nicole.mensforth@au.harveynorman.com	•			A
	Robe Hook	Parisi L'Hotel Robe Hook Code: NE021.131	нк	Brushed Chrome		Harvey Norman Nicole Mensforth 0400 981 608 nicole.mensforth@au.harveynorman.com	60			1
	Toilet Roll Holder	Parisi L'hotel Toilet Roll Holder Code: NE026.31	TRH	Brushed Chrome		Harvey Norman Nicole Mensforth 0400 981 608 nicole.mensforth@au.harveynorman.com				1



CONSTRUCTION CERTIFICATE NO. 8899-02-2019-CC

DATE ISSUED: 25/06/2019

I certify that work completed in accordance with these plans and specification will comply with the regulations referred to in section 81A(5) of the Environmental Planning and Assessment Act 1979.



TRENTON JONES FOR AE&D ACCREDITATION NO. BPB0203

NOTE:

1

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Project: 11-15 Mitchell Ave, Jannali FIXTURES, FITTINGS AND HARDWARE

NOT FOR CONSTRUCTION

ISSUE REVISION

1. Read this schedule in conjunction with architectural documentation, DA Consent & Conditions

AMENDMENT/ DESCRIPTION

Issued for D&C used during construction

Preliminary Issue

Issued for review

- Refer to service consultants specifications for all services layout & specifications
- Refer to Door / Window Schedule for Hardware
- Installation & Construction as per relevant BCA & Australian Standards

DATE

26/04/2018

12/04/2019

7/06/2019

5. Light / Dark Scheme to be coordinated by the builder

LOCATION	ITEM	MATERIAL/ DESCRIPTION	CODE	COLOUR/ RANGE	NOTES	SUPPLIER	IMAGE	BASIX PROV	BASIX REQ.	ISSUE
	Towel Rail	Parisi L'Hotel Towel Rail - 600mm Code: NE02812.131	TR1	Brushed Chrome		Harvey Norman Nicole Mensforth 0400 981 608 nicole.mensforth@au.harveynorman.com				1
	Shower Shelf	Parisi L'Hotel Soap Rack - 250mm Code: NE022B.31	SHELF	Brushed Chrome		Harvey Norman Nicole Mensforth 0400 981 608 nicole.mensforth@au.harveynorman.com				1
	Concealed Cistern	Parisi Inwali Concealed Cistern Code: PA136	CIST1			Harvey Norman Nicole Mensforth 0400 981 608 nicole.mensforth@au.harveynorman.com	3,5	4 Water	4 Water	1
	Push Button & Plates	Parisi Tondo Round Pushplate To Suit Inwall Cistern Code: PA221C	BUT1	Brushed Chrome		Harvey Norman Nicole Mensforth 0400 981 608 nicole.mensforth@au.harveynorman.com	Oo			1
	Plug and Waste Hand Basin	Parisi to suit basin	PLUG			Harvey Norman Nicole Mensforth 0400 981 608 nicole.mensforth@au.harveynorman.com				1



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LOCATION	ITEM	MATERIAL/ DESCRIPTION	CODE	COLOUR/ RANGE	NOTES	SUPPLIER	IMAGE	BASIX PROV	BASIX REQ.	ISSUE
	Floor Waste	FORME Square Waste Tile Insert 110x110x36mm Code: FD11XS90T C	FW1			Harvey Norman Nicole Mensforth 0400 981 608 nicole.mensforth@au.harveynorman.com				1
Laundry										
Fixtures and Fittings	Dryer	твс	DRY		Dryer with wall mounting kit					В
	Tub	TBC	TUB							В
	Mixer	TBC	MX5	Brushed Chrome						В
	Washing Machine	ТВС	WS							В
Hardware										
All Drawers	Drawer runners		HD1	Stainless Steel		Blum or approved equivalent				1
All Joinery Doors	Joinery hinges		HD2	Stainless Steel	-	Blum or approved equivalent				1
Wardrobes	Hanging rail		HD3	Matt Black		Builder's Preferred				1
All Bathrooms	Shower Screen Patch Fittings	Regency Semi-Frameless Shower Screen	HD5	Chrome		Regency screens or similar				1
Internal Sliding Doors	Recessed Handle	Lockwood Stainless Steel Flush Pulls Dims: 120x50mm Code: FP1-120	HD6	Satin stainless steel		Lockwood	ſ			1



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TRENTON JONES FOR AE&D ACCREDITATION NO. BPB0203

NOTE:

Project: 11-15 Mitchell Ave, Jannali

NOT FOR CONSTRUCTION

ISSUE REVISION

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- Refer to service consultants specifications for all services layout & specifications
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26/04/2018

12/04/2019

7/06/2019

LOCATION	ITEM	MATERIAL/ DESCRIPTION	CODE	COLOUR/ RANGE	NOTES	SUPPLIER	IMAGE	BASIX PROV	BASIX REQ.	ISSUE
All Apartment Doors incl. Entry Door	Lever Set	Lockwood 55mm Velocity Series Dianella Level 8	DH1	Satin Chrome Brushed	AS1428 COMPLIANT	Lockwood	œ			1
All Internal Doors	Lever Set	Lockwood 55mm Velocity Series Glide Level L4	DH2	Satin Chrome Brushed		Lockwood				1
All Bathrooms Door	Lever Set w/ privacy latch	Lockwood 55mm Velocity Series Glide Level L4 Glide Privacy Sets with Latch	DH3	Satin Chrome Brushed		Lockwood				1
Lighting General Area	Recessed Downlight	BLDL-007W-10 Dims: 109 x 73 mm - 95 mm Ø Light Source: 10W LED 300K	LT1	White		Bosco Lighting Gary Richards 02 9188 3471				1
Wet Areas	IP Rated Recessed Downlight	BLDL-007W-10 IP Rating 44 Dims: 109 x 73 mm - 95 mm Ø	LT2	White		Bosco Lighting Gary Richards 02 9188 3471	e			1
All Kitchens, Bathrooms & Ensuites	Recessed LED Lighting Strip	Light Source: 10W LED 300K BLEX-001-R Dims: 1600 x 24 x 9 mm 3000K	LT3	White	\$50 + GST	Bosco Lighting Gary Richards (02) 9188 3471				1
						(UZ) 3100 34/1	11			

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Project: 11-15 Mitchell Ave, Jannali
FIXTURES, FITTINGS AND HARDWARE
NOT FOR CONSTRUCTION
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ISSUE REVISION	DATE	AMENDMENT/ DESCRIPTION
1	26/04/2018	Preliminary Issue
A	12/04/2019	Issued for review
В	7/06/2019	Issued for D&C used during construction

NOTE:

1. Read this schedule in conjunction with architectural documentation, DA Consent & Conditions

2. Refer to service consultants specifications for all services layout & specifications

3. Refer to Door / Window Schedule for Hardware

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LOCATION	ITEM	MATERIAL/ DESCRIPTION	CODE	COLOUR/ RANGE	NOTES	SUPPLIER	IMAGE	BASIX PROV	BASIX REQ.	ISSUE
Terraces and Balconies	IP Rated Wall Mounted Light	Tiga LED 93024 Dim8 W IP65 Code: 223 751 811 932 ED8 W	LT4	White		Inlite James Lock 0467 168 822	Ĭ			1



CONSTRUCTION CERTIFICATE NO. 8899-02-2019-CC

DATE ISSUED: 25/06/2019

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TRENTON JONES FOR AE&D ACCREDITATION NO. BPB0203

Binay Kumar

From: Sent: To: Cc: Subject:	Kyra Donoso <kyrad@cpdm.com Tuesday, 14 May 2019 3:51 PM Binay Kumar; Albert Zhang Mark Jumikis FW: 8899-01-2019-CC 11-15 Mito</kyrad@cpdm.com 	
Flag Status:	Flagged	
FYI		
Kyra Donoso Assistant Development Manag	ี (รวช	M: +61 417 113 188 E: kyrad@cpdm.com.au Suite 02, Level 30, 133 Castlereagh St
CPORTCONFERS		Sydney 2000 NSW Australia

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From: Admin-AEDConsulting <<u>admin@aedconsulting.com.au</u>> Sent: Tuesday, May 14, 2019 3:37 PM To: '<u>kyrad@cpdm.com.au</u>' <<u>kyrad@cpdm.com.au</u>> Subject: 8899-01-2019-CC 11-15 Mitchell Avenue, Jannali

Dear Kyra,

We refer to your application for a Construction Certificate for the abovementioned project and advise that we have approved your application. The OneDrive link below contains the certification and all documents relied upon to make this determination as follows:

Construction Certificate No. 8899-01-2019-CC dated 10/05/2019

Plans and Specifications, stamped/certified by AED (as outlined in Schedule 1 of the Construction Certificate)

Attachments listed in Schedule 2 of the Construction Certificate

Notice to Commence Building Work & of a Principal Certifying Authority (PCA) emailed to Sutherland Shire Council on 10/05/2019 The Consent Authority must be advised two (2) days prior to works commencing.

https://aedconsultpty-

my.sharepoint.com/:u:/g/personal/tracy_aedconsulting_com_au/Ec8ce87CNW5FmoR1ThOY8TYBSAn1uofU5LKwaH aGx-CwRw?e=hgDemJ

In accordance with *Clause 142(2)* of the Environmental Planning & Assessment Regulation 2000, a copy of the above has also been submitted to Council.

Mitchell Ave Developments P/L vs Forte Sydney Constructions P/L Report issued: 25 February 2022

Mandatory inspections are applicable to this project in accordance with *Clause 162A of the Environmental Planning and Assessment Regulation 2000.* Failure to have these inspections carried out may result in Occupation Certificate not being issued. Reasonable notice is required to undertake these inspections.

Class 2 & 7a building:

No.	Critical Stage Inspection	Inspector
	First Footings After the commencement of the excavation for, and before the placement of, the first footing.	Certifying Authority
	Service Penetrations	
	Prior to covering of fire protection at service penetrations to building elements that are required to resist internal fire or smoke spread, inspection of a minimum of one of each type of protection method for each type of service, on each storey of the building comprising the building work.	Principal Certifier
	Bounding Wall Construction	
	Prior to covering the junction of any internal fire-resisting construction bounding a sole- occupancy unit (SOU), and any other building element required to resist internal fire spread, inspection of a minimum of 30% of SOUs on each storey of the building containing SOUs	Principal Certifier
	Waterproofing	
	Prior to covering of waterproofing in any wet areas, for a minimum of 10% of rooms with wet areas within a building. At least one unit is to be inspected.	Certifying Authority
	Stormwater	Cortifuing Authority
	Prior to covering any stormwater drainage connections	Certifying Authority
	Final	
	After the building work has been completed and prior to any Occupation Certificate being issued in relation to the building	Principal Certifier

A site sign will be sent via post today and is to be displayed on site at all times.

A copy of the approved plans and specifications, Development Consent and the Construction Certificate must be kept on-site at all times during construction.

If you require any further details please contact our office by phone (02) 9571 8433 or email <u>admin@aedconsulting.com.au</u>.

ADMINISTRATION AED



Head Office: Suite 3.04, 55 Miller Street, Pyrmont NSW 2009

Southern Highlands Office: Unit 10/19 Lyell Street, Mittagong NSW 2575

Sutherland Shire Office: Level 1 Regus, Suite 20, 29 Kiora Road, Miranda NSW 2228

Phone: 02-9571 8433 Email: admin@aedconsulting.com.au

www.aedconsulting.com.au I AED Capability Statement I AED Access Capability Statement I AED Fire Capability

Statement

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I certify that work completed in accordance with these plans and specification will comply with the regulations referred to in section 81A(5) of the Environmental Planning and Assessment Act 1979.



TRENTON JONES FOR AE&D ACCREDITATION NO. BPB0203

BCA Specification for 11-15 Mitchell Ave, Jannali

 Structural engineer to provide structural drawings/details and Glazin will comply with AS 1288-2006 and AS 2047-1999. Termite control will comply with AS 3660.1-2000 where any primar building elements are timber. If the building is in a flood hazard area it is required to comply with BC, clause B1.6.
Refer to Spec C1.1 and Attachment B for Schedule of FRLs for Type Construction. These are to be certified by the architect and structural enginee as having been met, based on the proposed design. Please note that specification C1.1 also requires design compliance with th
 Where a combustible material is used as a finish or lining to a wall or roo or sunscreen, or awning, to a building element required to have an FRL th material will be exempted or comply with the fire hazard propertie prescribed under C1.10 and will not otherwise constitute an undue risk of fire spread via the façade of the building or compromise egress from th building. This includes any aluminum panels which where containing plastis strengthening elements would not be non-combustible.
 Fire isolated shafts are required to be enclosed at the top and bottom of th shaft with fire rated construction as per specification C1.1. This fire rating required in two directions. The walls to fire rated shafts will achieve the fire rating from both direction
 i.e. from inside and outside the shaft. 4. Roof: The roof of the building does not need an FRL, provided the root covering is non-combustible (as per the concession in Clause 3.5 of Specification C1.1 of the BCA).
 Bounding construction to residential units will comply with the fire ratin requirements of table 3. Floors: see clause C2.9. In addition floors require an FRL of 90/90/90 when between residential levels and 120/120/120 where between carpark leve

C1.8 Lightweight construction	Where it is proposed to use <i>lightweight construction</i> this will comply with Specification C1.8 if it is used in a wall system—		
	(i) that is required to have an FRL; or		
	(ii) for a lift shaft, stair shaft or service shaft or an external wall bounding a public corridor including a non fire-isolated passageway or non fire- isolated ramp.		
	If lightweight construction is used for the fire-resisting covering of a steel column or the like, and if —		
	(i) the covering is not in continuous contact with the column, then the void will be filled solid, to a height of not less than 1.2 m above the floor to prevent indenting; and		
	(ii) the column is liable to be damaged from the movement of vehicles, materials or equipment, then the covering will be protected by steel or other suitable material.		
C1.9 Non-combustible buildir	• In a building required to be of Type A construction, the following building elements and their components will be non-combustible:		
elements	 External walls and common walls, including all components incorporated in them including the façade covering, framing and insulation 		
	- The flooring and floor framing of lift pits		
	- Non-loadbearing internal walls where they are required to be fire-resisting.		
	• A shaft, being a lift, ventilating, pipe, garbage, or similar shaft that is not for the discharge of hot products of combustion, that is non-loadbearing, will be of non-combustible construction in a building required to be of Type A construction;		
	• A loadbearing internal wall and a loadbearing fire wall, including those that are part of a loadbearing shaft, will comply with Specification C1.1.		
	• The requirements of (a) and (b) do not apply to gaskets, caulking, sealants and damp-proof courses.		
	• The following materials may be used wherever a non-combustible material is required:		
	- Plasterboard.		
	- Perforated gypsum lath with a normal paper finish.		
	- Fibrous-plaster sheet.		
	 Fibre-reinforced cement sheeting. Pre-finished metal sheeting having a combustible surface finish not 		
	exceeding 1 mm thickness and where the Spread-of-Flame Index of the product is not greater than 0.		
	- Bonded laminated materials where—		
	 each lamina, including any core, is non-combustible; and 		
	 each adhesive layer does not exceed 1 mm in thickness and the total thickness of the adhesive layers does not exceed 2 mm; and 		
	 the Spread-of-Flame Index and the Smoke-Developed Index of the bonded laminated material as a whole do not exceed 0 and 3 respectively. 		
C1.10	The fire hazard properties of the following linings, materials and assemblies will comply with Specification C1.10 by way of test reports / certificates provided		
Fire hazard properties	from a registered testing authority (within the meaning of the BCA):		
NSW C1.10 (b) Fire Hazar Properties			

(ii) Wall linings and ceiling linings.
(iii) Air-handling ductwork.
(iv) Lift cars.
(v) sarking-type materials
(vi) Attachments to floors, ceilings, internal walls and the internal linings of external walls.
(vii) Other materials including insulation materials other than sarking- type materials.
Except that:
 Paint or fire-retardant coatings will not be used to achieve compliance with the required fire hazard properties; and
 The requirements of this clause are exempted to the martials and assemblies listed under C1.10(c)(i) to (xiv)

Part C2

Compartmentation & Separation		
C2.6	Separation of windows will be provided with	
Vertical separation of openings in external walls	 a spandrel which is of non-combustible material having an FRL of not less than 60/60/60 a slab or other horizontal construction that is non-combustible and has an FRL of not less than 60/60/60. 	
C2.9 Separation of Classifications in	Parts of different classifications situated one above the other in adjoining storeys will be fire separated in accordance with this clause.	
different storeys	Floors separating the Basement 1 carpark and the Ground Floor residential will require an FRL of 120/120/120.	
	All elements providing lateral support to this floor require an FRL of 120/120/120 as per Clause 2.2 of Specification C1.1 of the BCA).	
C2.10 Separation of lifts shafts	The two proposed lifts connecting more than 2 storeys will be separated from the remainder of the building by enclosure in a fire rated shaft.	
	 Stair shafts within the basement carpark storeys require a FRL of 120/120/120 (if loadbearing) or -/120/120 (if non-loadbearing). Stair shafts within the residential storeys require a FRL of 90/90/90 (if loadbearing) or -/90/90 (if non-loadbearing) 	
C2.12	Any lift motor rooms, lift control panels, battery rooms, boilers rooms, will be two	
Separation of Equipment	hour fire separated as per this clause.	
C2.13 Electrical Supply	A main switch room housing emergency equipment which is required to operate in the emergency mode, will be fire separated from the remainder of the building in accordance with this Clause i.e. in construction achieving a FRL of not less than 120/120/120 with the access doorway provided with a self-closing fire door achieving a FRL of not less than -/120/30.	



Part C3 Protection of Openings	
C3.8 Openings in fire-isolated exits	Doorways to fire stairs will be self or auto closing -/60/30 fire doors.
C3.9 Service penetrations in fire- isolated exits	 The fire isolated exits are not to be penetrated by any services other than water supply pipes for fire services OR electrical wiring associated with: a lighting, detection, or pressurization system serving the exit; or a security, surveillance or management system serving the exit; or an intercommunication system or an audible or visual alarm system in accordance with D2.22 (it is noted that re-entry from fire-isolated exits will not be required); or the monitoring of hydrant or sprinkler isolating valves
C3.10 Openings in fire-isolated lift shafts	 Lifts landing doors are required to be fire doors with an FRL of -/60/- that comply with AS 1735.11-1986, and be set to remain closed except when discharging or receiving, passengers, goods or vehicles. Lift indicator panels will also be fire rated in accordance with this clause.
C3.11 Bounding construction: Class 2 and 3 buildings and 4 parts	The doorways between sole occupancy units and the public lobbies and any common rooms and the public lobbies (class 2 parts) will be protected by self-closing -/60/30 fire doors (for Type A construction).
C3.12 Openings in floors and ceilings for services	Where services pass through a floor which is required to achieve a FRL or a ceiling required to have a RISF, the service will be enclosed within a fire resisting shaft or fire protected in accordance with Clause C3.15.
C3.13 Openings in shafts	In a building of Type A construction, an opening in a wall providing access to a ventilating, pipe, garbage or other service shaft will be fire protected in accordance with this clause.
C3.15 Openings for service installations	Where services pass through an element which is required to achieve a FRL (other than an external wall or roof), the service will be fire protected in accordance with this clause.

C3.16 Construction joints	Construction joints, spaces and the like in and between building elements required to be fire-resisting with respect to integrity and insulation will be protected in a manner identical with a prototype tested in accordance with AS 1530.4 to achieve the required FRL.
C3.17	Any columns protected in fire rated plasterboard to be compliant with this clause.
Columns protected in lightweight construction to achieve an FRL	
SECTION D ACCESS & EGRESS	
Part D1 Provision for Escape	
D1.6 Dimensions of exits and paths of travel to exits	In a required exit or path of travel to an exit— (a) the unobstructed height throughout will be not less than 2 m, except the unobstructed height of any doorway may be reduced to not less than 1980 mm; and
	(b) the unobstructed width of each exit or path of travel to an exit, except for doorways, will be not less than 1 m
D1.10 Discharge from exits	a) An exit will not be blocked at the point of discharge and where necessary, suitable barriers will be provided to prevent vehicles from blocking the exit, or access to it.
	(b) If a required exit leads to an open space, the path of travel to the road will have an unobstructed width throughout of not less than—
	(i) the minimum width of the required exit;
	(ii) or 1 m,
	whichever is the greater.
	(c) If an exit discharges to open space that is at a different level than the public road to which it is connected, the path of travel to the road will be by—
	(i) a ramp or other incline having a gradient not steeper than 1:8 at any part, or not steeper than 1:14 if required by the Deemed-to-Satisfy Provisions of Part D3.
	(d) The discharge point of alternative exits will be located as far apart as practical.
D1.16	a) A ladder may be used in lieu of a stairway to provide egress from—
Plant Rooms and lift Motor	(i) a plant room with a floor area of not more than 100 m ² ; or
Rooms: Concession	(ii) all but one point of egress from a plant room, a lift machine room or a Class 8 electricity network substation with a floor area of not more than 200 m2.
	(b) A ladder permitted under (a)—
	(i) may form part of an exit provided that in the case of a fire-isolated stairway it is contained within the shaft; or
	(ii) may discharge within a storey in which case it will be considered as forming part of the path of travel; and
	(iii) for a plant room or a Class 8 electricity network substation, will comply with AS 1657; and
	(iv) for a lift machine room, where access is provided from within a machine room to a secondary floor, a fixed rung type ladder complying with AS 1657 may be used, provided that—

(A) the height between the floors is not more than 2800 mm; and
(B) the ladder is inclined at an angle to the horizontal not less than 65 degrees nor more than 75 degrees; and
(C) the distance between the front face of the ladder and any adjacent obstruction is not less than—
(aa) 960 mm, where the ladder is inclined 65 degrees to the horizontal; or
(bb) 760 mm, where the ladder is inclined 75 degrees to the horizontal; or
(cc) a distance that is determined by interpolating the values in (aa) and (bb), where the ladder is inclined at any angle between 65 degrees and 75 degrees to the horizontal; and
(D) a clear space not less than 600 mm exists between the foot of the ladder and any equipment.

Part D2

Construction of Exits

D2.2 Fire-Isolated stairways and ramps	The fire isolated stairways will be constructed of non-combustible materials and constructed so that if there is local failure it will not cause structural damage to, or impair the fire-resistance of the shaft.
D2.7 Installations in exits and paths of travel	Any electricity meters, distribution boards; telecommunications distribution boards or equipment; electrical motors or other motors within corridors/hallways/lobbies or the like will be enclosed with non-combustible construction or a fire protective covering with doorways suitably sealed against smoke spread.
	Electrical wiring may be installed with a fire isolated exit, but only where associated with a lighting, detection, pressurisation, security, surveillance, intercommunication, or hydraulic fire services monitoring valves.
D2.10 Pedestrian ramps	All pedestrian ramps are to have a non-slip finish complying with AS 4586-2013 Slip resistance classification of new pedestrian surface materials. Clause contains additional information relevant to fire isolation and access requirements applicable to pedestrian ramps.
D2.12 Roof as Open Space	The roof of the carpark will achieve an FRL of 120/120/120 and not have any roof lights or other openings within 3m of the path of travel of persons using the exit to reach the road.
D2.13 Goings and risers	Stairways to achieve compliance with this clause relevant to going and riser dimensions. Treads will have a surface with a slip-resistant classification not less than that listed in Table D2.14 when tested in accordance with AS 4586-2013 Slip
	resistance classification of new pedestrian surface materials. BCA 2016 Amendment 1 does not directly specify slip-resistance classification(s) for all accessible paths of travel; however, we highlight the need under AS 1428.1-2009 for all accessible paths of travel to have a slip-resistant surface. We recommend you should seek surface finish advice from an independent specialist slip safety consultant.
D2.14 Landings	Landings will not be less than 750mm long and have a slip-resistant classification not less than that listed in Table D2.14 when tested in accordance with <i>AS</i> 4586-2013 Slip resistance classification of new pedestrian surface materials.

	BCA 2016 Amendment 1 does not directly specify slip-resistance classification(s) for all <i>accessible paths of travel</i> ; however, we highlight the need under AS 1428.1-2009 for all <i>accessible paths of travel</i> to have a slip-resistant surface. We recommend you should seek surface finish advice from an independent specialist slip safety consultant.		
D2.15 Thresholds	The threshold of a doorway will not incorporate a step or ramp at any point closer to the doorway than the width of the door leaves unless the doorway is in a building required to be accessible by Part D3, and in which case the doorway opens to a road or open space and is provided with a threshold ramp or step ramp in accordance with AS 1428.1.		
D2.16 Balustrades and other Barriers Note NSW D2.16	Balustrades will be provided to stairs and balconies, driveway ramps etc where there is a fall of more than 1m.		
	Balustrades in fire-isolated stairways shall comply with D2.16 (g) and (h)(i) and all other balustrades shall comply with D2.16(g) and (h)(ii).		
	Face plate fixing mechanism will not extend further than 10mm from the balustrade surface		
	REARBLESS GLASS RALISTRATE WITH ALUMBER TOP RAL LAPPENG ALLOW AUXIMITER WITH SOLUCE FAXS POUNTER		
D2.17	All stairways and ramps will be provided with a handrail as per this clause.		
Handrails	A required exit serving an area required to be accessible will be designed and constructed to comply with Clause 12 of AS 1428.1, except that Clause 12(d) does not apply to a handrail required by (a)(iii)(B).		
	All ramps with a gradient steeper than 1:20 or more will be provided with a handrail as per this clause, including any driveway ramps that form paths of travel to the street.		
	See also clause D3.3 regarding handrail requirements to assist people with a disability.		
D2.18	Plant areas may be accessed via stairs and ladders compliant with AS 1657-		
Fixed Platforms, walkways and ladders	2013.		
D2.21 Operation of Latch	All doors in a required exit or forming part of a required exit AND doors in a path of travel to a required exit will be readily openable without a key from the side that faces a person seeking egress, by single hand downward action or pushing action on a single device which is located between 900mm and 1.1 m from the floor and if serving an area required to be accessible by Part D3 –		
	A. be such that the hand of a person who cannot grip will not slip from the handle during the operation of the latch; and		
	B. have a clearance between the handle and the back plate or door face at the center grip section of the handle of not less than 35mm and not more than 45mm; or		
	C. a single hand pushing action on a single device which is located between 900mm and 1.2m from the door.		

	The above requirements do not apply to doors that serve only or is within a SOU in a Class 2 building.
D2.23 Signs on Doors	Signs on required fire doors to alert persons that the operation of these doors is not to be impaired. Refer also to offence signage required by Clause 183 of the EP&A Regulation 2000.
D2.24 Protection of openable windows	The protection of openable bedroom windows in a Class 2 , 3 or 4 building, where the floor below the window is 2 m or more above the surface beneath it; AND
	For protection of openable windows of other classifications where the floor below the window is 4 m or more above the surface beneath it.

SECTION E	
SERVICES & EQUIPMENT	

Part E1		
Fire Fighting Equipment		
E1.4 Fire hose reels	A fire hose reel system complying with AS 2441-2005 will be provided to serve the basement carpark where internal fire hydrants area installed OR where internal fire hydrants are not installed, to serve any fire compartment with a floor area greater than 500m2.	
E1.6 Portable Fire Extinguishers	Portable fire extinguishers will be provided in accordance with Table E1.6 of the BCA and will be selected, located and distributed in accordance with Sections 1, 2, 3 and 4 of AS 2444-2001. Note: Portable fire extinguishers now required to serve Class 2 buildings to cover Class A fire risks, where: Internal fire hydrants area installed; and	
E1.9 Fire Precautions during construction	 During construction, not less than one portable fire extinguisher to suit Class A, B and C fires and electrical fires will be provided at all times on each storey adjacent to each required / temporary exit; and After the building has reach an effective height of 12m, the required fire hydrants and fire hose reels will be operational on all floor / roof covered storeys, except for the 2 uppermost storeys; and All required booster connections will be installed. 	

Part E2

Smoke Hazard Management E2.2 General smoke hazard management requirements **General Requirements** An air-handling system which does not form part of a smoke hazard management system in accordance with Table E2.2a or Table E2.2b and which (inclusive of Table E2.2a / Table recycles air from one fire compartment to another fire compartment or operates E2.2b & NSW amendments) in a manner that may unduly contribute to the spread of smoke from one fire compartment to another fire compartment (such as lobby air supply) will-(i) be designed and installed to operate as a smoke control system in accordance with AS/NZS 1668.1; or (ii) (A) incorporate smoke dampers where the air-handling ducts penetrate any elements separating the fire compartments served; and

	(B) be arranged such that the air-handling system is shut down and the smoke dampers are activated to close automatically by smoke detectors complying with clause 4.10 of AS/NZS 1668.1; and for the purposes of this provision, each sole-occupancy unit in a Class 2 or 3 building is treated as a separate fire compartment.
	Miscellaneous air-handling systems covered by Sections 5 and 11 of AS/NZS 1668.1 serving more than one fire compartment (other than a carpark ventilation system) and not forming part of a smoke hazard management system will comply with that Section of the Standard.
	Note: Smoke alarms in sole occupancy units now required to be interconnected.
	Class 2 (residential)
	Class 2 part will be provided an automatic smoke detection and alarm system complying with Specification E2.2a;
	Class 7a buildings
	A Class 7a building including a basement provided with a mechanical ventilation system in accordance with AS 1668.2 will comply with clause 5.5 of AS/NZS 1668.1 except that fans with metal blades for operation at normal temperatures may be used, and the electrical power and control cabling need not be fire rated.
	Carparks are required to be provided with a smoke detection system complying with AS $1670.1 - 2015$.
Part E3	
Lift Installations	

E3.1 Lift installations	An electric passenger lift installation and an electrohydraulic passenger lift installation will comply with Specification E3.1
E3.2 Stretcher Facility in Lifts	Stretcher facilities in lifts are required to any building requiring an emergency lift required by E3.4, and where passenger lifts area installed to serve any storey above an effective height of 12m or more. A stretcher lift will accommodate a raised stretcher with a patient lying on it horizontally by providing a clear space not less than 600mm wide x 2000mm long x 1400mm high above floor level.
E3.3 Warning Against the use of lifts in Fire	Warning signs indicating "Do not use lifts if there is a fire" shall be displayed near every call button for a passenger lift or group of lifts throughout a building as per E3.3.
E3.5 Landings	Access and egress to and from lift-well landings will comply with the Deemed- to-Satisfy Provisions of Section D.
E3.6 Facilities for People with Disabilities	In an accessible building, every passenger lift will be one of the types specified in Table E3.6a, have accessible features in accordance with Table E3.6b, and not rely on a constant pressure device for its operation if the lift car is fully enclosed.
E3.7 Fire Service Controls	Lifts serving any storey above an effective height of 12m will be provided with a: fire service recall control switch complying with E3.9 (for a group of lifts or a single lift not in a group that serves the storey); and lift car fire drive control switch complying with E3.10 for every lift.
E3.9	Fire service recall control switch requirements will comply with this clause.

	Report Issued. 201 Obradily 2022	
Fire service recall operation switch		
E3.10 Lift car fire service drive control switch	specific lift car fire service drive control switch requirements will comply with this clause.	
Part E4		
Emergency Lighting, Exit Signs ar	nd Warning Systems	
E4.4 Design and Operation of Emergency Lighting	The emergency lighting system will comply with AS 2293.1-2005.	
E4.8 Design & Operation of Exit Signs	 Exit signs will comply with: AS 2293.1-2005; or For a photoluminescent exit sign, Specification E4.8. 	
SECTION F HEALTH & AMENITY		
Part F1 Damp & Weatherproofing		
F1.1 Stormwater Drainage	Stormwater drainage will comply with AS/NZS 3500.3-2015.	
F1.4 External above ground membranes	Any external above ground membranes will be waterproofed as per AS 4654 Parts 1 and 2-2012.	
F1.5 Roof coverings	A roof will be covered with metal sheet roofing complying with AS 1562.1.	
F1.6 Sarking	Sarking-type materials used for weatherproofing will comply with AS/NZS 4200 Part 1 and 2-1994.	

F1.7 Waterproofing of wet area	Wet areas will be waterproofed in accordance with AS 3740-2010 and F1.7 of the BCA.
F1.9 Damp-proofing	Where a damp-proof course is required, it will consist of a material that complies with AS/NZS 2904-1995; or impervious sheet material in accordance with AS 3660.1-2000
F1.10 Damp-proofing of floors on the ground	If a floor of a room is laid on the ground or on fill, moisture from the ground will be prevented from reaching the upper surface of the floor and adjacent walls by the insertion of a vapour barrier in accordance with AS 2870-2011 (N/A to areas that do not require weatherproofing – refer specific clause exemptions).
F1.11	Bathrooms and laundries in Class 2 building will be provided with a floor waste, and the floor of such areas will be graded to such floor waste.

Provision of Floor Wastes					
F1.13 Glazed Assemblies	glazed assemblies within external walls in accordance with AS 2047-1999.				
Part F2 Sanitary & Other Facilities					
Part F3 Room Sizes					
F3.1			Х	The ceiling height will be not less than-	
Height of Rooms and other				(a) in a Class 2—	
spaces				(i) a kitchen, laundry, or the like — 2.1 m;	
				(ii) and a corridor, passageway or the like — 2.1 m; and	
				(iii) a habitable room excluding a kitchen — 2.4 m; and	
				(iv) in a room or space with a sloping ceiling or projections below the ceiling line within -	
				(A) a habitable room—	
				(aa) in an attic — a height of not less than 2.2 m for not less than two thirds of the floor area of the room or space; and	
				(bb) in other rooms — a height of not less than 2.4 m for not less than two thirds of the floor area of the room or space; and	
				(B) a non-habitable room — a height of not less than 2.1 m for not less than two thirds of the floor area of the room or space; and when calculating the floor area of a room or space, any part that has a ceiling height of less than 1.5 m is not included; and	
				(b) in a Class 7 buildings—	
				(i) except as allowed in (ii) and (f) — 2.4 m; and	
				(ii) a corridor, passageway, or the like — 2.1 m; and	

Part F4

Light & Ventilation

F4.1 Provision of natural light	Natural lighting will be provided to all habitable rooms in Class 2 buildings.
F4.2 Methods and extent of natural lighting	Required natural lighting will be provided by— (i) windows, excluding roof lights, that— (A) have an aggregate light transmitting area measured exclusive of framing members, glazing bars or other obstructions of not less than 10% of the floor area of the room; and (B) are open to the sky or face a court or other space open to the sky or an open verandah, carport or the like; or
	(ii) roof lights, that—

	(A) have an aggregate light transmitting area measured exclusive of framing members, glazing bars or other obstructions of not less than 3% of the floor area of the room; and
	(B) are open to the sky; or
	(iii) a proportional combination of windows and roof lights required by (i) and (ii).
F4.4 Artificial lighting	Artificial lighting in accordance with AS/NZS 1680.0-2009 to specific building areas.
F4.5 Ventilation of Rooms	All rooms to be provided with Clause F4.6 compliant natural ventilation OR a mechanical ventilation or air-conditioning system complying with AS 1668.2-2012.
F4.6 Natural Ventilation	(a) Natural ventilation provided in accordance with F4.5(a) will consist of permanent openings, windows, doors or other devices which can be opened—
	(i) with ventilating area not less than 5% of the floor area of the room required to be ventilated; and
	(ii) open to—
	(A) a suitably sized court, or space open to the sky; or
	(B) an open verandah, carport, or the like; or
	(C) an adjoining room in accordance with F4.7.
F1.11	Every storey of a carpark will have:
Carparks	 a system of mechanical ventilation complying with AS1668.2-2012; or a system of natural ventilation complying with Section 4 of AS 1668.4-2012.
Part F5 Sound Transmission	
F5.2	A form of construction required to have an airborne sound insulation rating will-
Determination of airborne sound insulation ratings	(a) have the required value for weighted sound reduction index (Rw) or weighted sound reduction index with spectrum adaptation term (Rw + Ctr) determined in accordance with AS/NZS 1276.1 or ISO 717.1 using results from laboratory measurements; or
	(b) comply with Specification F5.2.
F5.3	(a) A floor in a building required to have an impact sound insulation rating will-
Determination of impact sound insulation ratings	(i) have the required value for weighted normalised impact sound pressure level (Ln,w) determined in accordance with AS/ISO 717.2 using results from laboratory measurements; or
	(ii) comply with Specification F5.2.
	(b) A wall in a building required to have an impact sound insulation rating will—
	(i) for a Class 2 or 3 building be of discontinuous construction; and
F5.4	A floor in a Class 2 or 3 building will achieve an $R_w + C_{tr}$ (airborne) not less than
Sound Insulation of floors	50, and an Ln,w (impact) not more than 62, if separating:
between units	 SOU's; or An SOU from a plant room, lift shaft, public corridor, public lobby or parts of a different classification.

	- A floor in a Class 9c aged care building separating SOU's will achieve an $R_{\rm w}$ not less than 50.
F5.5	(a) A wall in a Class 2 or 3 building will—
Sound insulation of walls between units	(i) have an Rw + Ctr (airborne) not less than 50, if it separates sole-occupancy units; and
	(ii) have an Rw (airborne) not less than 50, if it separates a sole-occupancy unit from a plant room, lift shaft, stairway, public corridor, public lobby or the like, or parts of a different classification; and
	(iii) comply with F5.3(b) if it separates—
	(A) a bathroom, sanitary compartment, laundry or kitchen in one sole-occupancy unit from a habitable room (other than a kitchen) in an adjoining unit; or
	(B) a sole-occupancy unit from a plant room or lift shaft.
	(b) A door may be incorporated in a wall in a Class 2 or 3 building that separates a sole occupancy unit from a stairway, public corridor, public lobby or the like, provided the door assembly has an Rw not less than 30.
	(c) A wall in a Class 9c aged care building will have an Rw not less than 45 if it separates—
	(i) sole-occupancy units; or
	(ii) a sole-occupancy unit from a kitchen, bathroom, sanitary compartment (not being an associated ensuite), laundry, plant room or utilities room.
	(e) Where a wall required to have sound insulation has a floor above, the wall will continue to—
	(i) the underside of the floor above; or
	(ii) a ceiling that provides the sound insulation required for the wall.
	(f) Where a wall required to have sound insulation has a roof above, the wall will continue to—
	(i) the underside of the roof above; or
	(ii) a ceiling that provides the sound insulation required for the wall.
F5.6 Sound insulation rating of services	Ducts and pipes will achieve an $R_w + C_{tr}$ (airborne) of no less than 40 if the adjacent room is habitable or 25 if non-habitable.
F5.7	Х
Sound isolation of pumps	A flexible coupling will be used at the point of connection between the service pipes in a building and any circulating pump.
SECTION G ANCILLIARY PROVISIONS	

Part G1 Minor Structures and Components	5
NSW G1.101 Provision for cleaning windows	A safe manner for cleaning of windows located 3 or more storeys above ground level will be provided, and compliance is achieved where:
	 The windows can be cleaned wholly from within the building; or Via a method complying with the Work Health and Safety Act 2011 and regulations made under that Act.

SECTION J ENERGY EFFICIENCY			
NSW SECTION J			
ENERGY EFFICIENCY			
NSW SUBSECTION J(A) ENERGY EFFICIENCY - CLASS 2 BUILDINGS AND CLASS 4 PARTS	The requirements of the BASIX Certificate will be incorporated into the design.		
NSW J(A)1 BUILDING FABRIC			
NSW J(A)1.1	Part J(A)1 is only applicable to Class 2 buildings, and Class 4 parts of a building,		
Application of Part	where a development consent or complying development certificate specifies that thermal insulation is to be provided as part of the development.		
NSW J(A)1.2 Compliance with BCA provisions	Class 2 buildings and Class 4 parts of buildings, will comply with the National Provisions of J0.2(b) to (e) i.e.:		
	(b) for general thermal construction, comply with J1.2; and		
	(c) for thermal breaks, comply with J1.3(d) and J1.5(c); and		
	(d) for compensating for a loss of ceiling insulation, comply with J1.3(c); and		
	(e) for floor edge insulation, comply with J1.6(c) and J1.6(d); and		
NSW J(A)2 BUILDING SEALING			
NSW J(A)2.1 Application of Part	The requirements of this Part are applicable to Class 2 buildings and Class 4 parts of buildings, excluding:		
	 A building in a climate zones 2 and 5 where the only means of air-conditioning is by using an evaporative cooler; A building ventilation opening necessary for the safe operation of a gas appliance; parts of the building that cannot be fully enclosed. 		
NSW J(A)2.2 Compliance with BCA Provisions	Class 2 buildings and Class 4 parts of buildings, will comply with the following National Provisions:		
Compliance with BCA Fromsions	(a) J3.2 Chimneys and flues;		
	(b) J3.3 Roof lights;		
	(c) J3.4 External doors and windows;		
	(d) J3.5 Exhaust fans;		
	(e) J3.6 Construction of roofs walls and floors; and		
	(f) J3.7 Evaporative coolers.		
NSW J(A)3 AIR CONDITIONING	AND VENTILATING SYSTEMS		
NSW J(A) 3.2 Compliance with BCA Provisions	Class 2 buildings and Class 4 part of a building will comply with the following national BCA provisions (as applicable):		
	(a) J5.2 (a) to (d) and (f) to (g) Air conditioning systems; and (b) J5.3 Mechanical ventilation systems; and		

- (b) J5.3 Mechanical ventilation systems; and
- (c) J5.4 Miscellaneous exhaust systems.

	Note : Compliance is not required with the national BCA provisions of J5.2(e) as those matters are regulated under BASIX.
NSW J(A)4 HOT WATER SUPPL	Y
NSW J(A)4.2 Compliance with BCA Provisions	A Class 2 building and Class 4 part of a building will comply with the following National BCA provisions of Clause J7.2. Note: Compliance is not required with the national BCA provisions of J7.3 and J7.4 as those matters are regulated under BASIX.
NSW J(A)5 ACCESS FOR MAINT	ENANCE
NSW J(A)5.3 Compliance with BCA provisions	Class 2 buildings will comply with the national BCA provisions of J8.3



BASEMENT B2 CONCRETE OUTLINE PLAN - 100 SLAB ON GROUND U.N.O.

SLABS ON GROUND TO BE CAST ON 0.2mm THICK HIGH IMPACT RESISTANCE FILM TO AS/NZS 4347 OVER A 50mm SAND BED / REINFORCE SLABS ON GROUND WITH 1 LAYER OF SL82 FABRIC TOP THROUGHOUT 30 COVER.

CONCRETE OUTLINES, LEVELS, SETDOWNS, REBATES, FALLS & PENETRATIONS TO ARCHITECTS DETAILS. REFER TO HYDRAULIC ENGINEER'S DETAILS FOR ALL SUB SOIL DRAINAGE, SUMPS, PITS AND GRATED DRAINS U.N.O.

CROSS-HATCHING DENOTES 120 THICK DRIVEWAY RAMP WITH 300 x 300 THICKENED EDGES CAST ON 0.2mm THICK HIGH IMPACT RESISTANCE FILM TO AS/NZS 4347 OVER 100 BASECOURSE BLINDED WITH SAND. PROVIDE SL82 FABRIC TOP

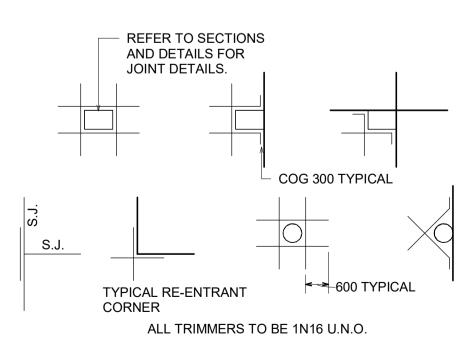
THE BASEMENT IS DESIGNED AS A DRAINED BASEMENT WITH PERMANENT SUB-FLOOR DRAINAGE CONNECTED TO A SUMP AND PUMP DEWATERING SYSTEM TO HYDRAULIC ENGINEERS DESIGN. REFER TO GEOTECHNICAL REPORT FROM JK GEOTECHNICS GEOTECHINCAL & ENVIRONMENTAL ENGINEERS DATED 21st OF MARCH 2017. PROVIDE KEYED JOINTS (K.J.) OR DOWELLED EXPANSION JOINTS (D.E.J.) AT ALL CONSTRUCTION JOINTS. ALL SERVICES CAST INTO SLAB MUST BE APPROVED BY XAVIER KNIGHT PRIOR TO CONSTRUCTION. RW1 DENOTES 200mm THICK DINCEL RETAINING WALL. REFER TO DRAWING S0211 FOR DETAILS.



DATE ISSUED: 10/05/2019

I certify that work completed in accordance with these plans and specification will comply with the regulations referred to in section 81A(5) of the Environmental Planning and Assessment Act 1979.

TRENTON JONES FOR AE&D ACCREDITATION NO. BPB0203




TYPICAL SLAB ON GROUND TRIMMER DETAILS AT ALL COLUMNS, WALLS, PITS, FLOOR WASTES, ETC THAT CAUSE A PENETRATION THROUGH THE SLAB.

ect	
EMENT LEVEL B2	
ICRETE OUTLINE PLAN	

Scale at A1
As indicated
Job No
181026

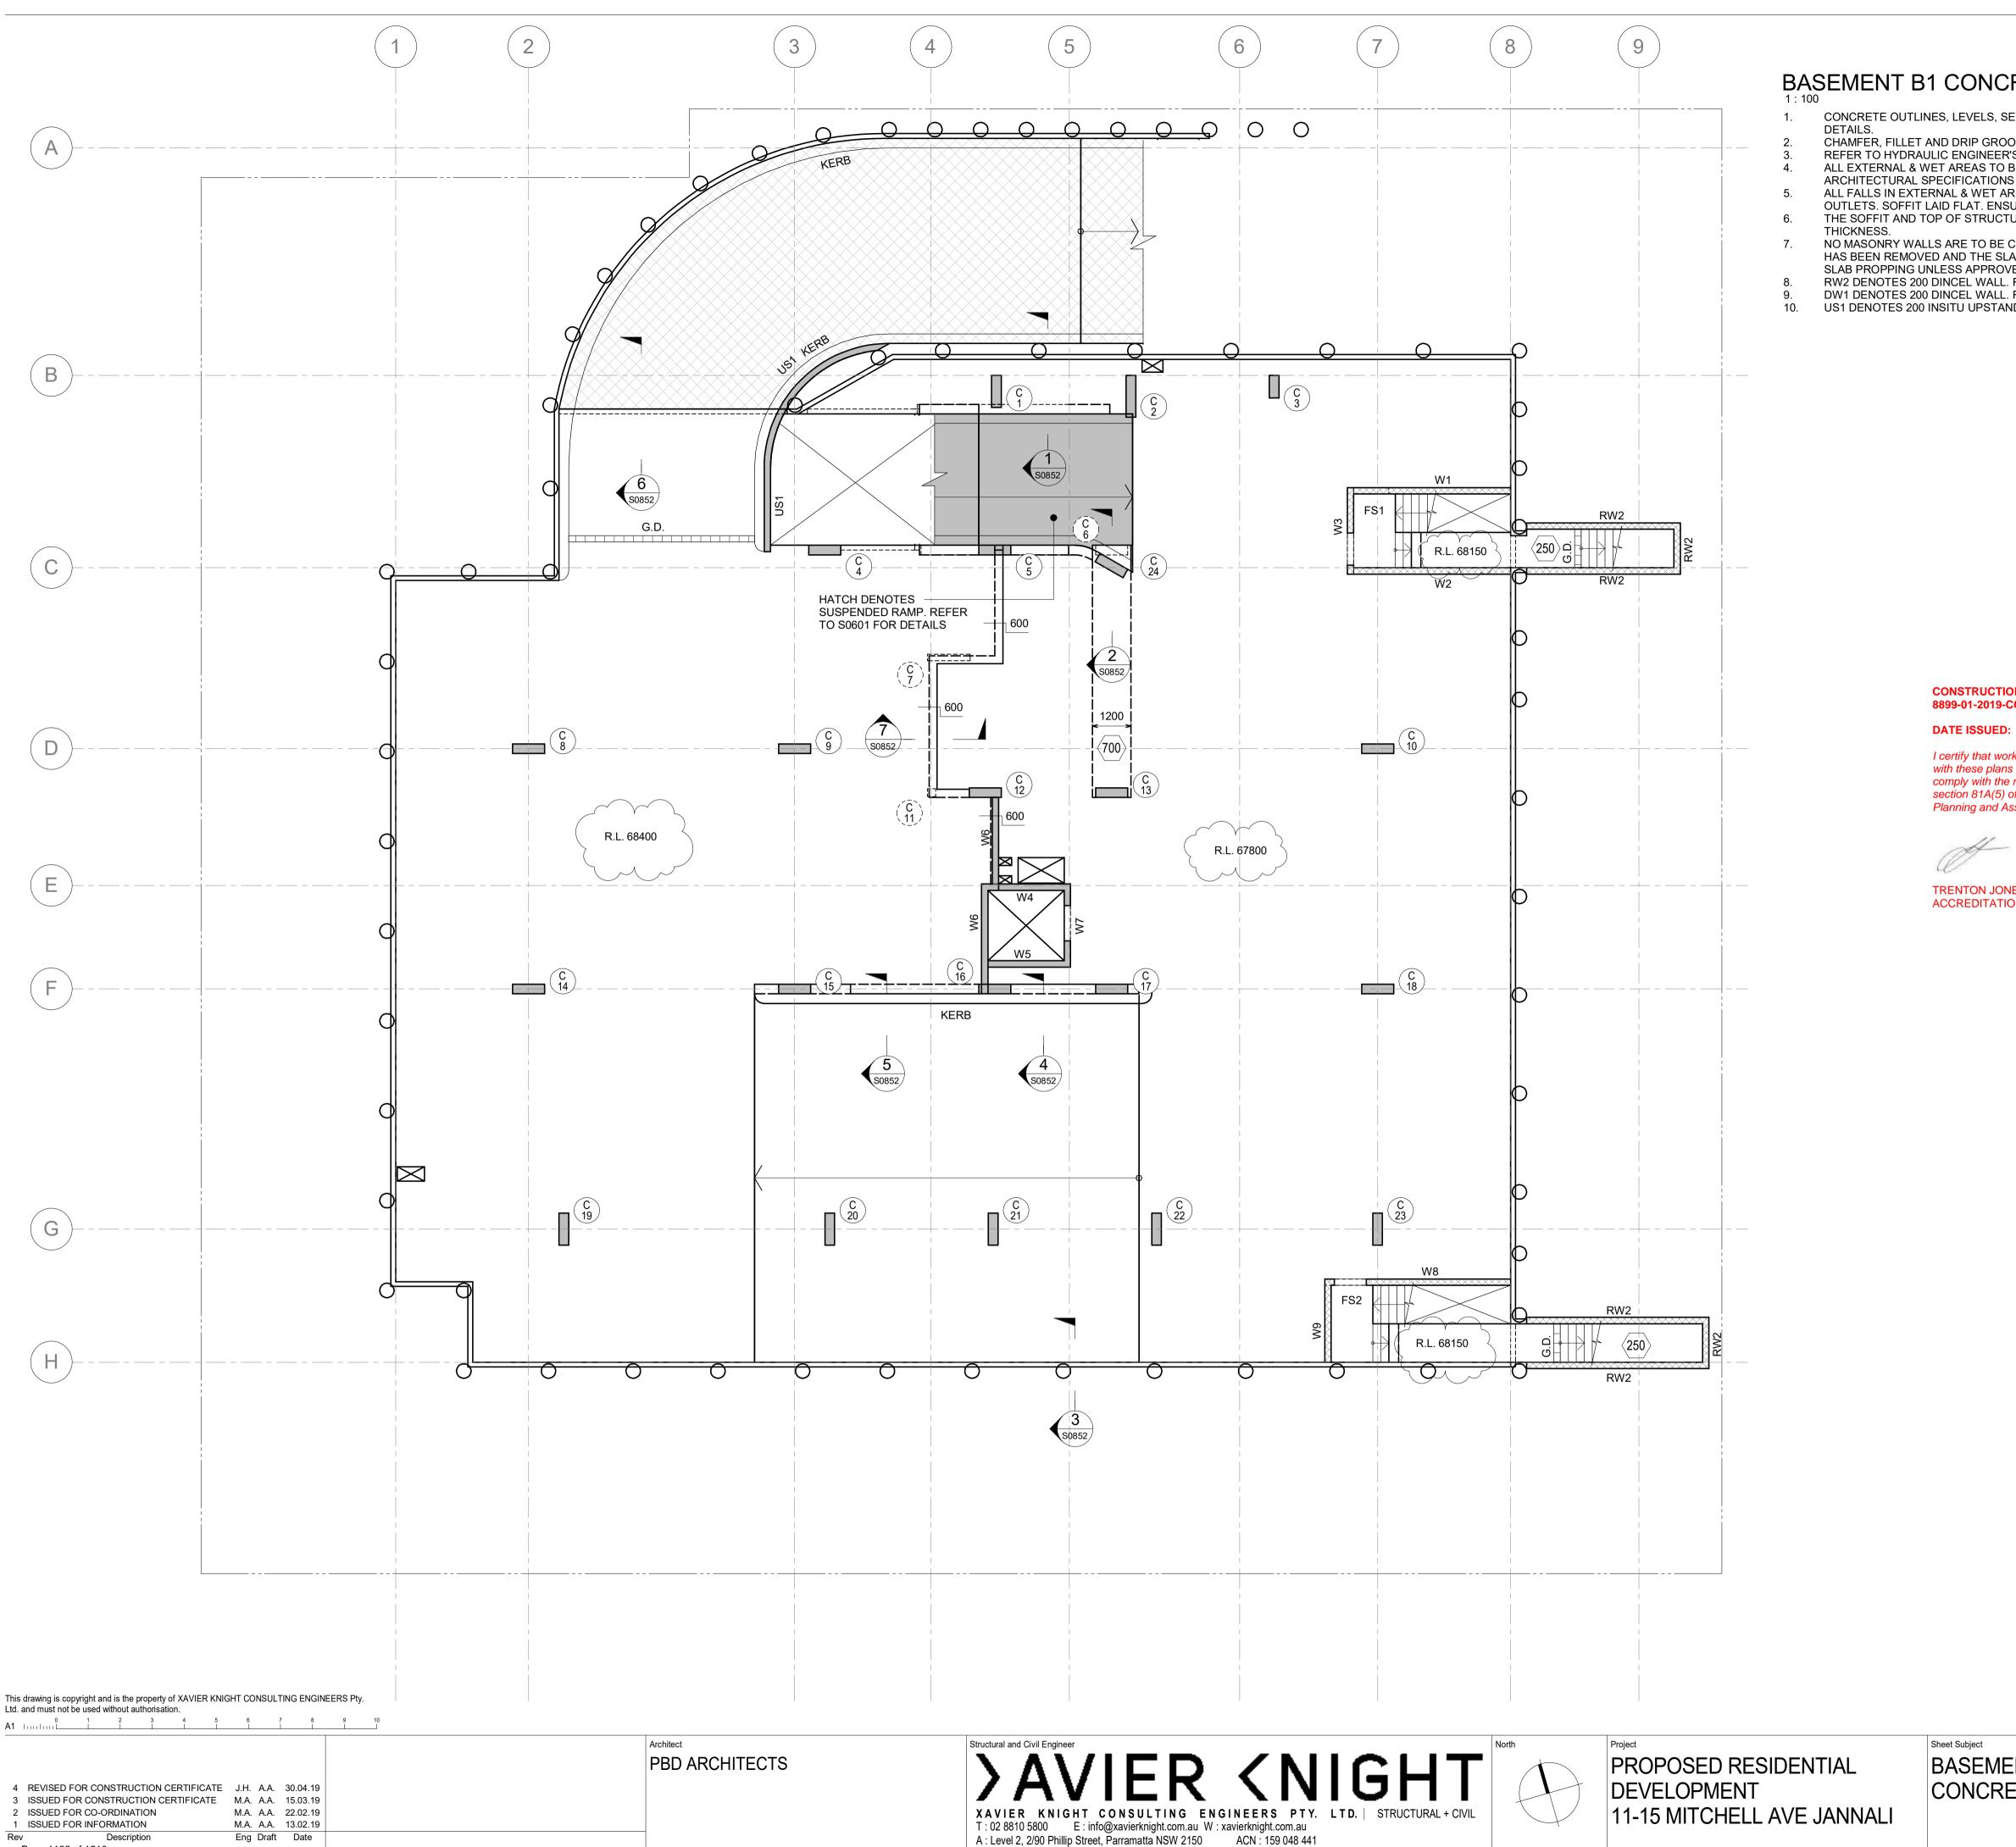Drawn AA Drawing No S0701 Approved



Sheet Subject BASEMENT LEVEL B1 CONCRETE OUTLINE PLAN

BASEMENT B1 CONCRETE OUTLINE PLAN - 250 SUSPENDED SLAB U.N.O.

CONCRETE OUTLINES, LEVELS, SETDOWNS, REBATES, FALLS & PENETRATIONS TO ARCHITECTS

CHAMFER, FILLET AND DRIP GROOVES TO ARCHITECT DETAILS AND TO BUILDER REQUIREMENTS. REFER TO HYDRAULIC ENGINEER'S DRAWINGS FOR SUMPS, PITS AND GRATED DRAINS. ALL EXTERNAL & WET AREAS TO BE WATERPROOFED & INSULATED IN ACCORDANCE WITH THE

ALL FALLS IN EXTERNAL & WET AREAS TO BE MADE IN THE TOP OF STRUCTURAL SLAB TO HYDRAULIC OUTLETS. SOFFIT LAID FLAT. ENSURE MINIMUM CONCRETE THICKNESS ARE MAINTAINED. THE SOFFIT AND TOP OF STRUCTURAL SLABS ARE LAID TO FALLS. MAINTAIN MIN CONCRETE

NO MASONRY WALLS ARE TO BE CONSTRUCTED ON SUSPENDED LEVELS UNTIL THE SLAB PROPPING HAS BEEN REMOVED AND THE SLAB HAS ABSORBED ITS DEAD LOAD DEFLECTION. DO NOT REMOVE SLAB PROPPING UNLESS APPROVED BY THE ENGINEER. RW2 DENOTES 200 DINCEL WALL. RETAIING WALL. REFER TO DRAWING S0852 FOR DETAILS. DW1 DENOTES 200 DINCEL WALL. REFER TO DRAWING Sxxx FOR DETAILS. US1 DENOTES 200 INSITU UPSTAND WALL. REFER TO DRAWING S0851 FOR DETAILS.



DATE ISSUED: 10/05/2019

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TRENTON JONES FOR AE&D ACCREDITATION NO. BPB0203


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Approved

Job No 181026 Drawing No S0801

Revisior



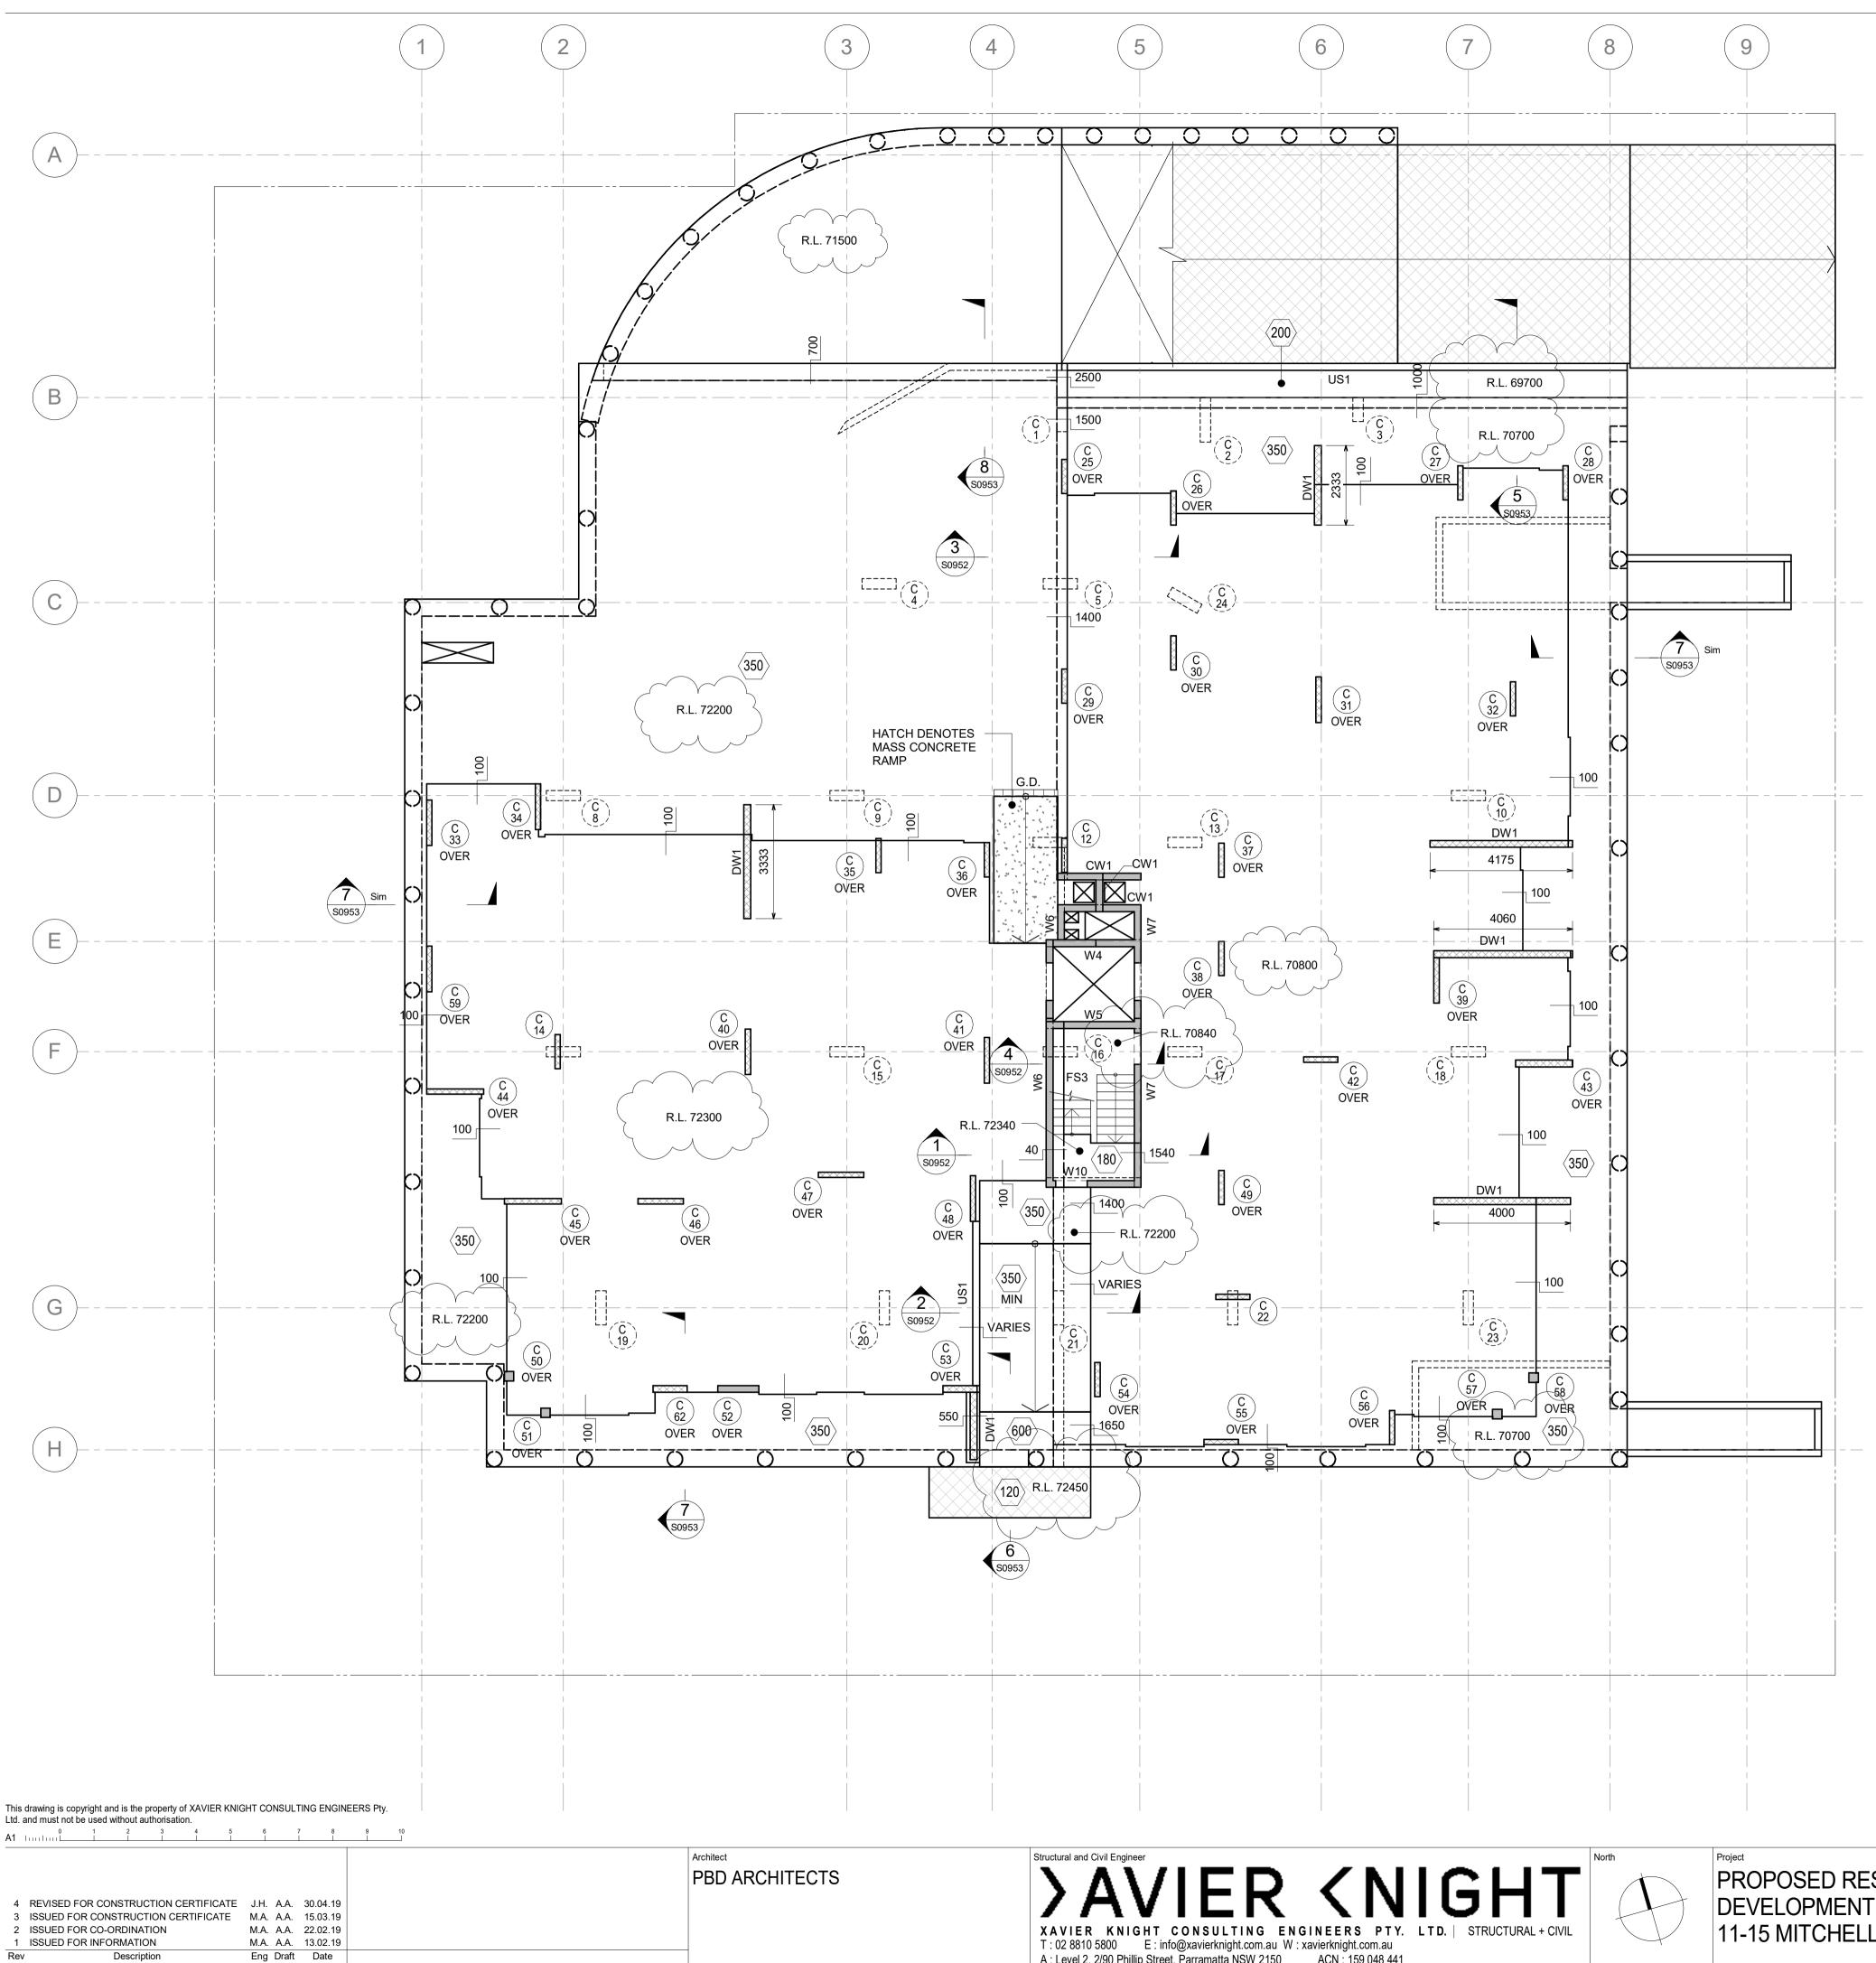- Page 1123 of 1510

2 ARCHITECTURAL SPECIFICATIONS PROPPING UNLESS APPROVED BY THE ENGINEER. 8 POST TENSIONING BRIEF. 9 PROFILES AS REQUIRED. 10. 11. 12. 13.

PROPOSED RESIDENTIAL 11-15 MITCHELL AVE JANNALI



A : Level 2, 2/90 Phillip Street, Parramatta NSW 2150 ACN : 159 048 441

GROUND FLOOR CONCRETE OUTLINE PLAN - 450 THICK SLAB U.N.O.

CONCRETE OUTLINES, LEVELS, SETDOWNS, REBATES, FALLS & PENETRATIONS TO ARCHITECTS DETAILS. CHAMFER, FILLET AND DRIP GROOVES TO ARCHITECT DETAILS AND TO BUILDER REQUIREMENTS. REFER TO HYDRAULIC ENGINEER'S DRAWINGS FOR SUMPS, PITS AND GRATED DRAINS. ALL EXTERNAL & WET AREAS TO BE WATERPROOFED & INSULATED IN ACCORDANCE WITH THE

ALL FALLS IN EXTERNAL & WET AREAS TO BE MADE IN THE TOP OF STRUCTURAL SLAB TO HYDRAULIC OUTLETS. SOFFIT LAID FLAT. ENSURE MINIMUM CONCRETE THICKNESS ARE MAINTAINED. THE SOFFIT AND TOP OF STRUCTURAL SLABS ARE LAID TO FALLS. MAINTAIN MIN CONCRETE THICKNESS. NO MASONRY WALLS ARE TO BE CONSTRUCTED ON SUSPENDED LEVELS UNTIL THE SLAB PROPPING HAS BEEN REMOVED AND THE SLAB HAS ABSORBED ITS DEAD LOAD DEFLECTION. DO NOT REMOVE SLAB

POST TENSIONING AND REINFORCEMENT IN SLABS, BANDS BEAMS & SLAB FOLDS TO BE DESIGNED AND CERTIFIED BY THE POST TENSIONING SUBCONTRACTOR TO MEET XAVIER KNIGHT CONSULTING ENGINEERS

DENOTES SERVICE ZONE ALLOCATION IN SLAB. POST TENSIONING CONTRACTOR TO CO-ORDINATE

THE POST TENSIONING CONTRACTOR MUST NOT DESIGN FOR LIVE END ANCHORS IN EXPOSED SLAB & EDGES UNLESS APPROVED BY XAVIER KNIGHT.

A ROOF SAFETY ACCESS SYSTEM WHICH COMPLIES WITH THE RELEVANT OH & S REGULATIONS FOR FALL ARREST AND THE RELEVANT AUSTRALIAN STANDARDS IS TO BE INSTALLED AND CERTIFIED BY AN APPROPRIATELY EXPERIENCED SPECIALIST SUPPLIER. THE DESIGN BY THE SPECIALIST IS TO INCLUDE SYSTEM SELECTION, LAYOUT, INSTALLATION, FLASHING, STRENGTHENING WORKS AND CERTIFICATION. DW1 DENOTES 200 DINCEL WALL. REFER TO DRAWING S0412 FOR DETAILS.

US1 DENOTES 200 UPSTAND WALL. REFER TO DRAWING S0951 FOR DETAILS.



DATE ISSUED: 10/05/2019

I certify that work completed in accordance with these plans and specification will comply with the regulations referred to in section 81A(5) of the Environmental Planning and Assessment Act 1979.

TRENTON JONES FOR AE&D ACCREDITATION NO. BPB0203

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Approved

Job No 181026 Drawing No S0901 Revision



Rev

A : Level 2, 2/90 Phillip Street, Parramatta NSW 2150 ACN : 159 048 441

LEVEL 1 CONCRETE OUTLINE PLAN - 200 THICK SLAB U.N.O.

CONCRETE OUTLINES, LEVELS, SETDOWNS, REBATES, FALLS & PENETRATIONS TO ARCHITECTS DETAILS. CHAMFER, FILLET AND DRIP GROOVES TO ARCHITECT DETAILS AND TO BUILDER REQUIREMENTS. REFER TO HYDRAULIC ENGINEER'S DRAWINGS FOR SUMPS, PITS AND GRATED DRAINS. ALL EXTERNAL & WET AREAS TO BE WATERPROOFED & INSULATED IN ACCORDANCE WITH THE

ALL FALLS IN EXTERNAL & WET AREAS TO BE MADE IN THE TOP OF STRUCTURAL SLAB TO HYDRAULIC

OUTLETS. SOFFIT LAID FLAT. ENSURE MINIMUM CONCRETE THICKNESS ARE MAINTAINED. THE SOFFIT AND TOP OF STRUCTURAL SLABS ARE LAID TO FALLS. MAINTAIN MIN CONCRETE THICKNESS.

NO MASONRY WALLS ARE TO BE CONSTRUCTED ON SUSPENDED LEVELS UNTIL THE SLAB PROPPING HAS BEEN

REMOVED AND THE SLAB HAS ABSORBED ITS DEAD LOAD DEFLECTION. DO NOT REMOVE SLAB PROPPING

DW1 DENOTES 200 DINCEL WALL. REFER TO DRAWING S0412 FOR DETAILS.



DATE ISSUED: 10/05/2019

I certify that work completed in accordance with these plans and specification will comply with the regulations referred to in section 81A(5) of the Environmental Planning and Assessment Act 1979.

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TRENTON JONES FOR AE&D ACCREDITATION NO. BPB0203

LEVEL 1 CONCRETE OUTLINE


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Approved

Job No 181026

Drawing No S1001 Revisior



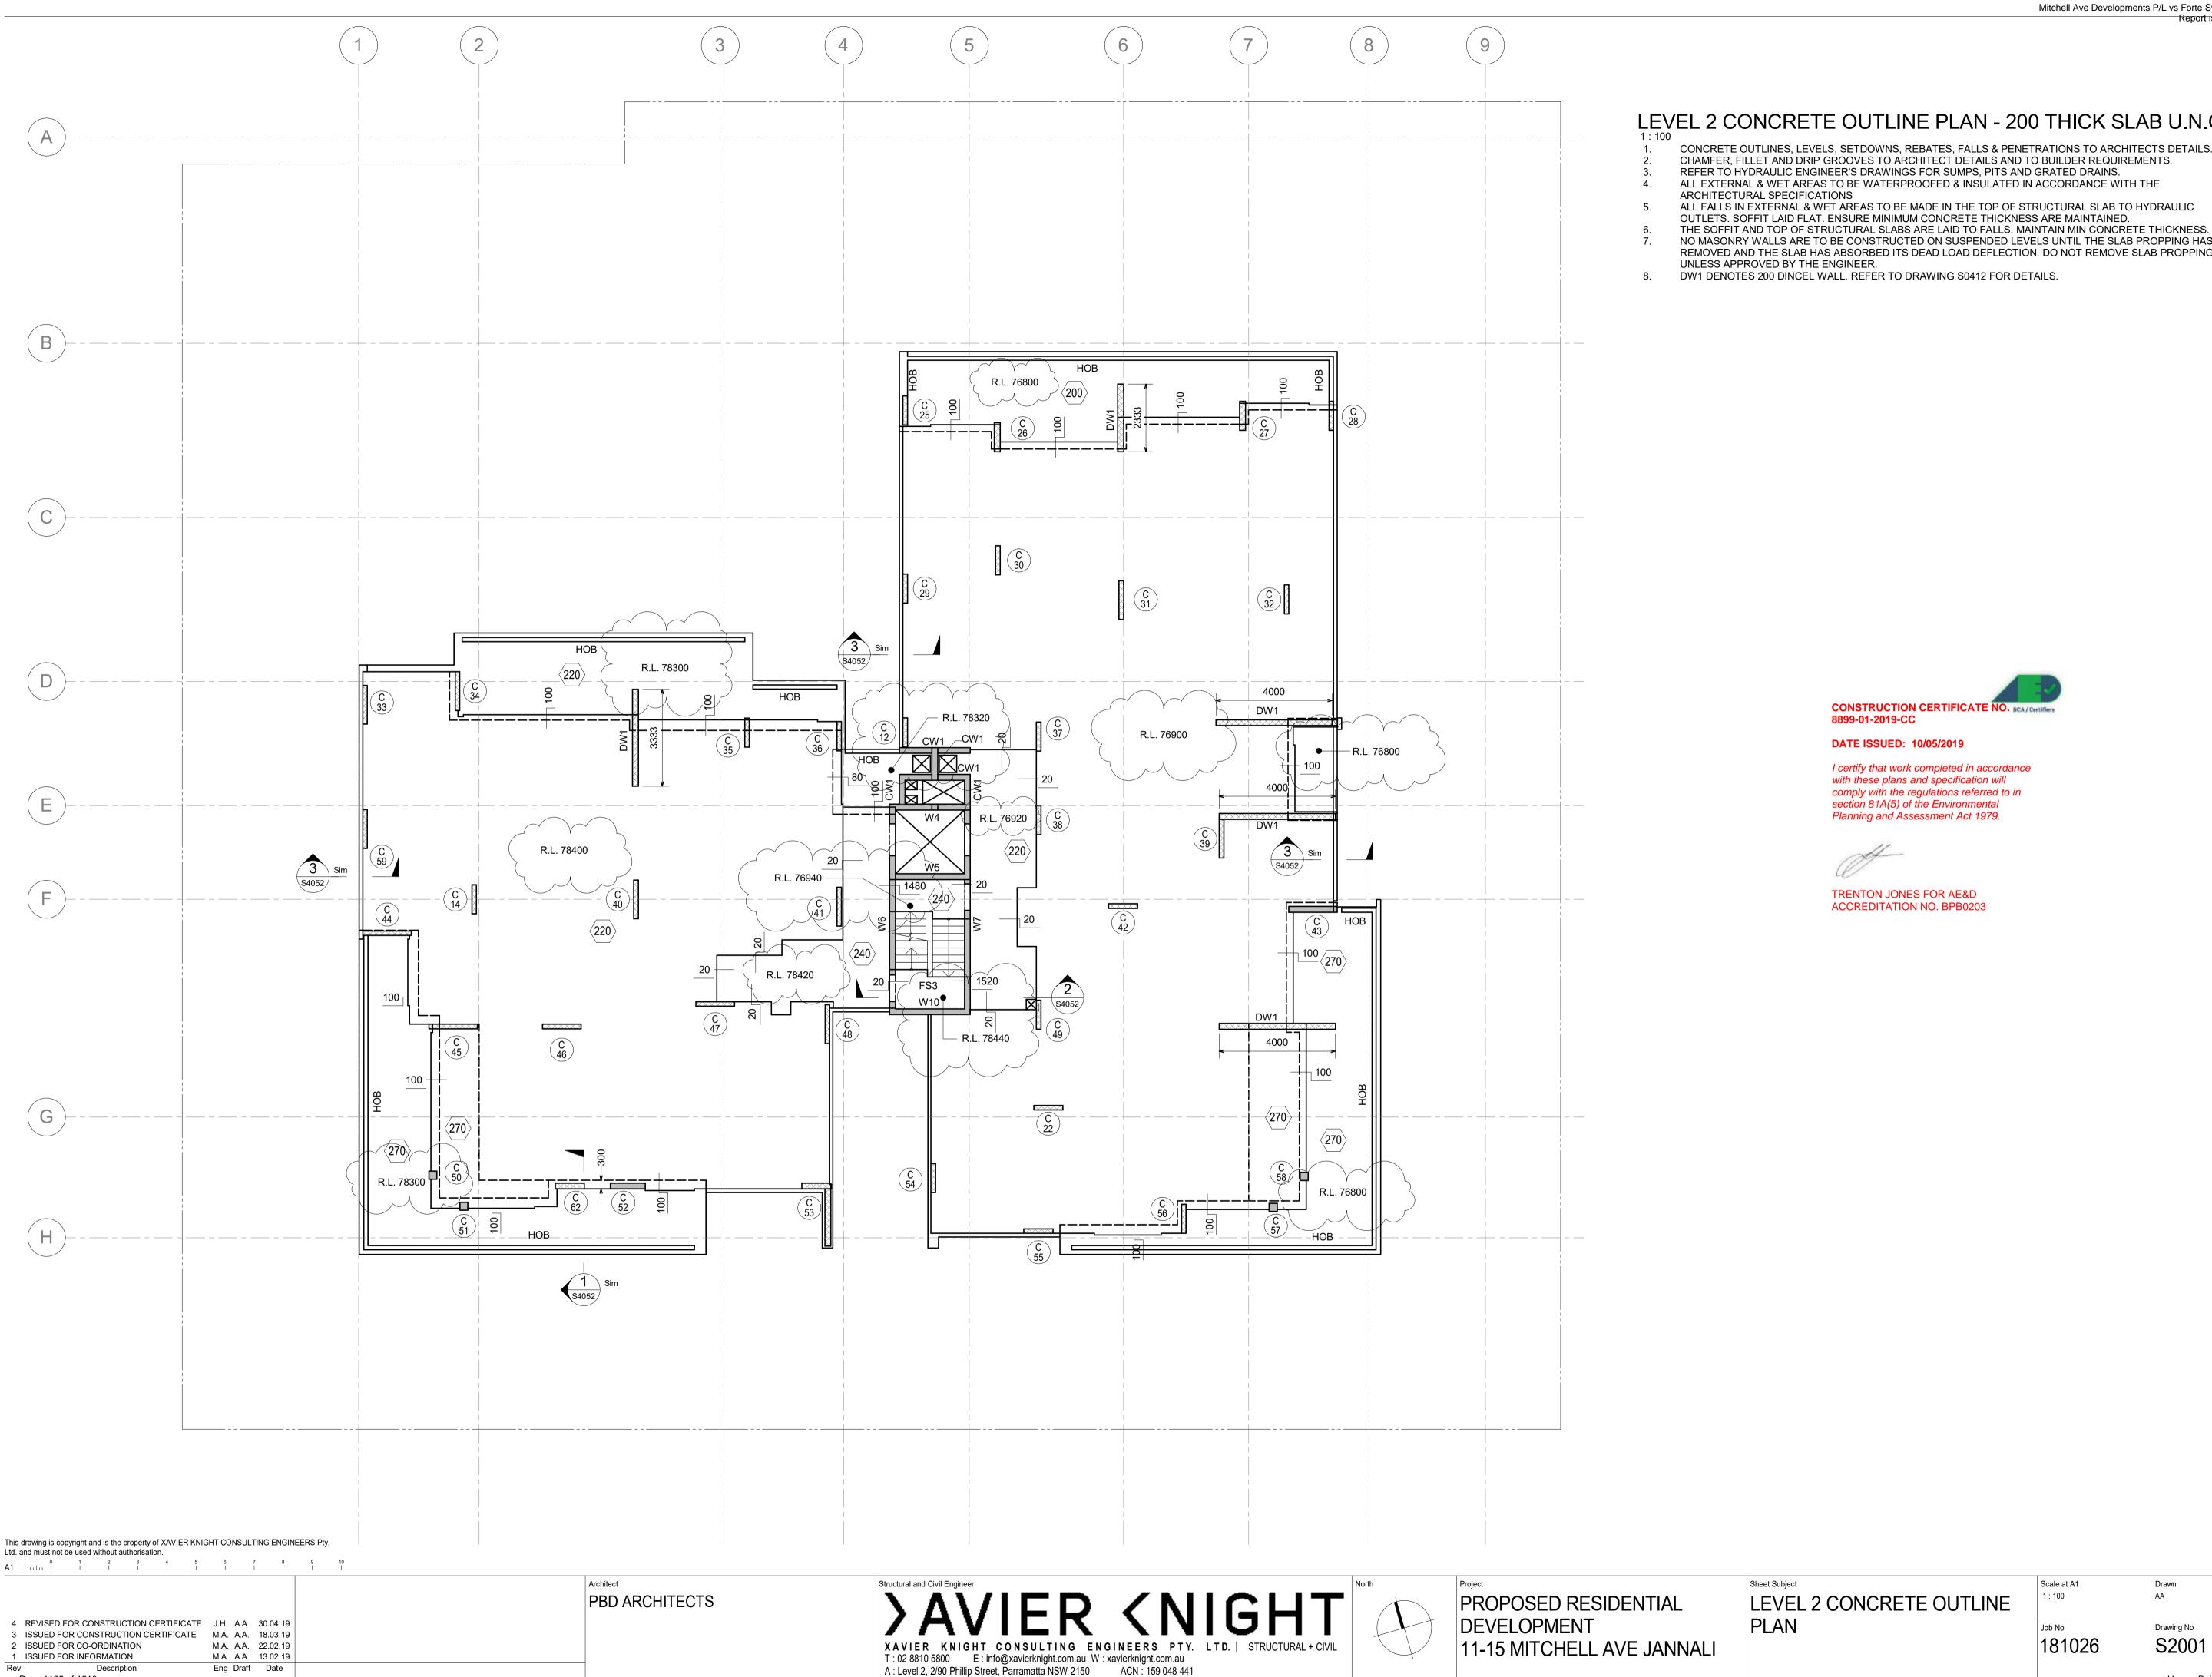LEVEL 2 CONCRETE OUTLINE PLAN - 200 THICK SLAB U.N.O.

CONCRETE OUTLINES, LEVELS, SETDOWNS, REBATES, FALLS & PENETRATIONS TO ARCHITECTS DETAILS. CHAMFER, FILLET AND DRIP GROOVES TO ARCHITECT DETAILS AND TO BUILDER REQUIREMENTS. REFER TO HYDRAULIC ENGINEER'S DRAWINGS FOR SUMPS, PITS AND GRATED DRAINS. ALL EXTERNAL & WET AREAS TO BE WATERPROOFED & INSULATED IN ACCORDANCE WITH THE

NO MASONRY WALLS ARE TO BE CONSTRUCTED ON SUSPENDED LEVELS UNTIL THE SLAB PROPPING HAS BEEN REMOVED AND THE SLAB HAS ABSORBED ITS DEAD LOAD DEFLECTION. DO NOT REMOVE SLAB PROPPING



I certify that work completed in accordance with these plans and specification will comply with the regulations referred to in section 81A(5) of the Environmental Planning and Assessment Act 1979.

S	Ca	ale at A1	
1	:	100	

181026

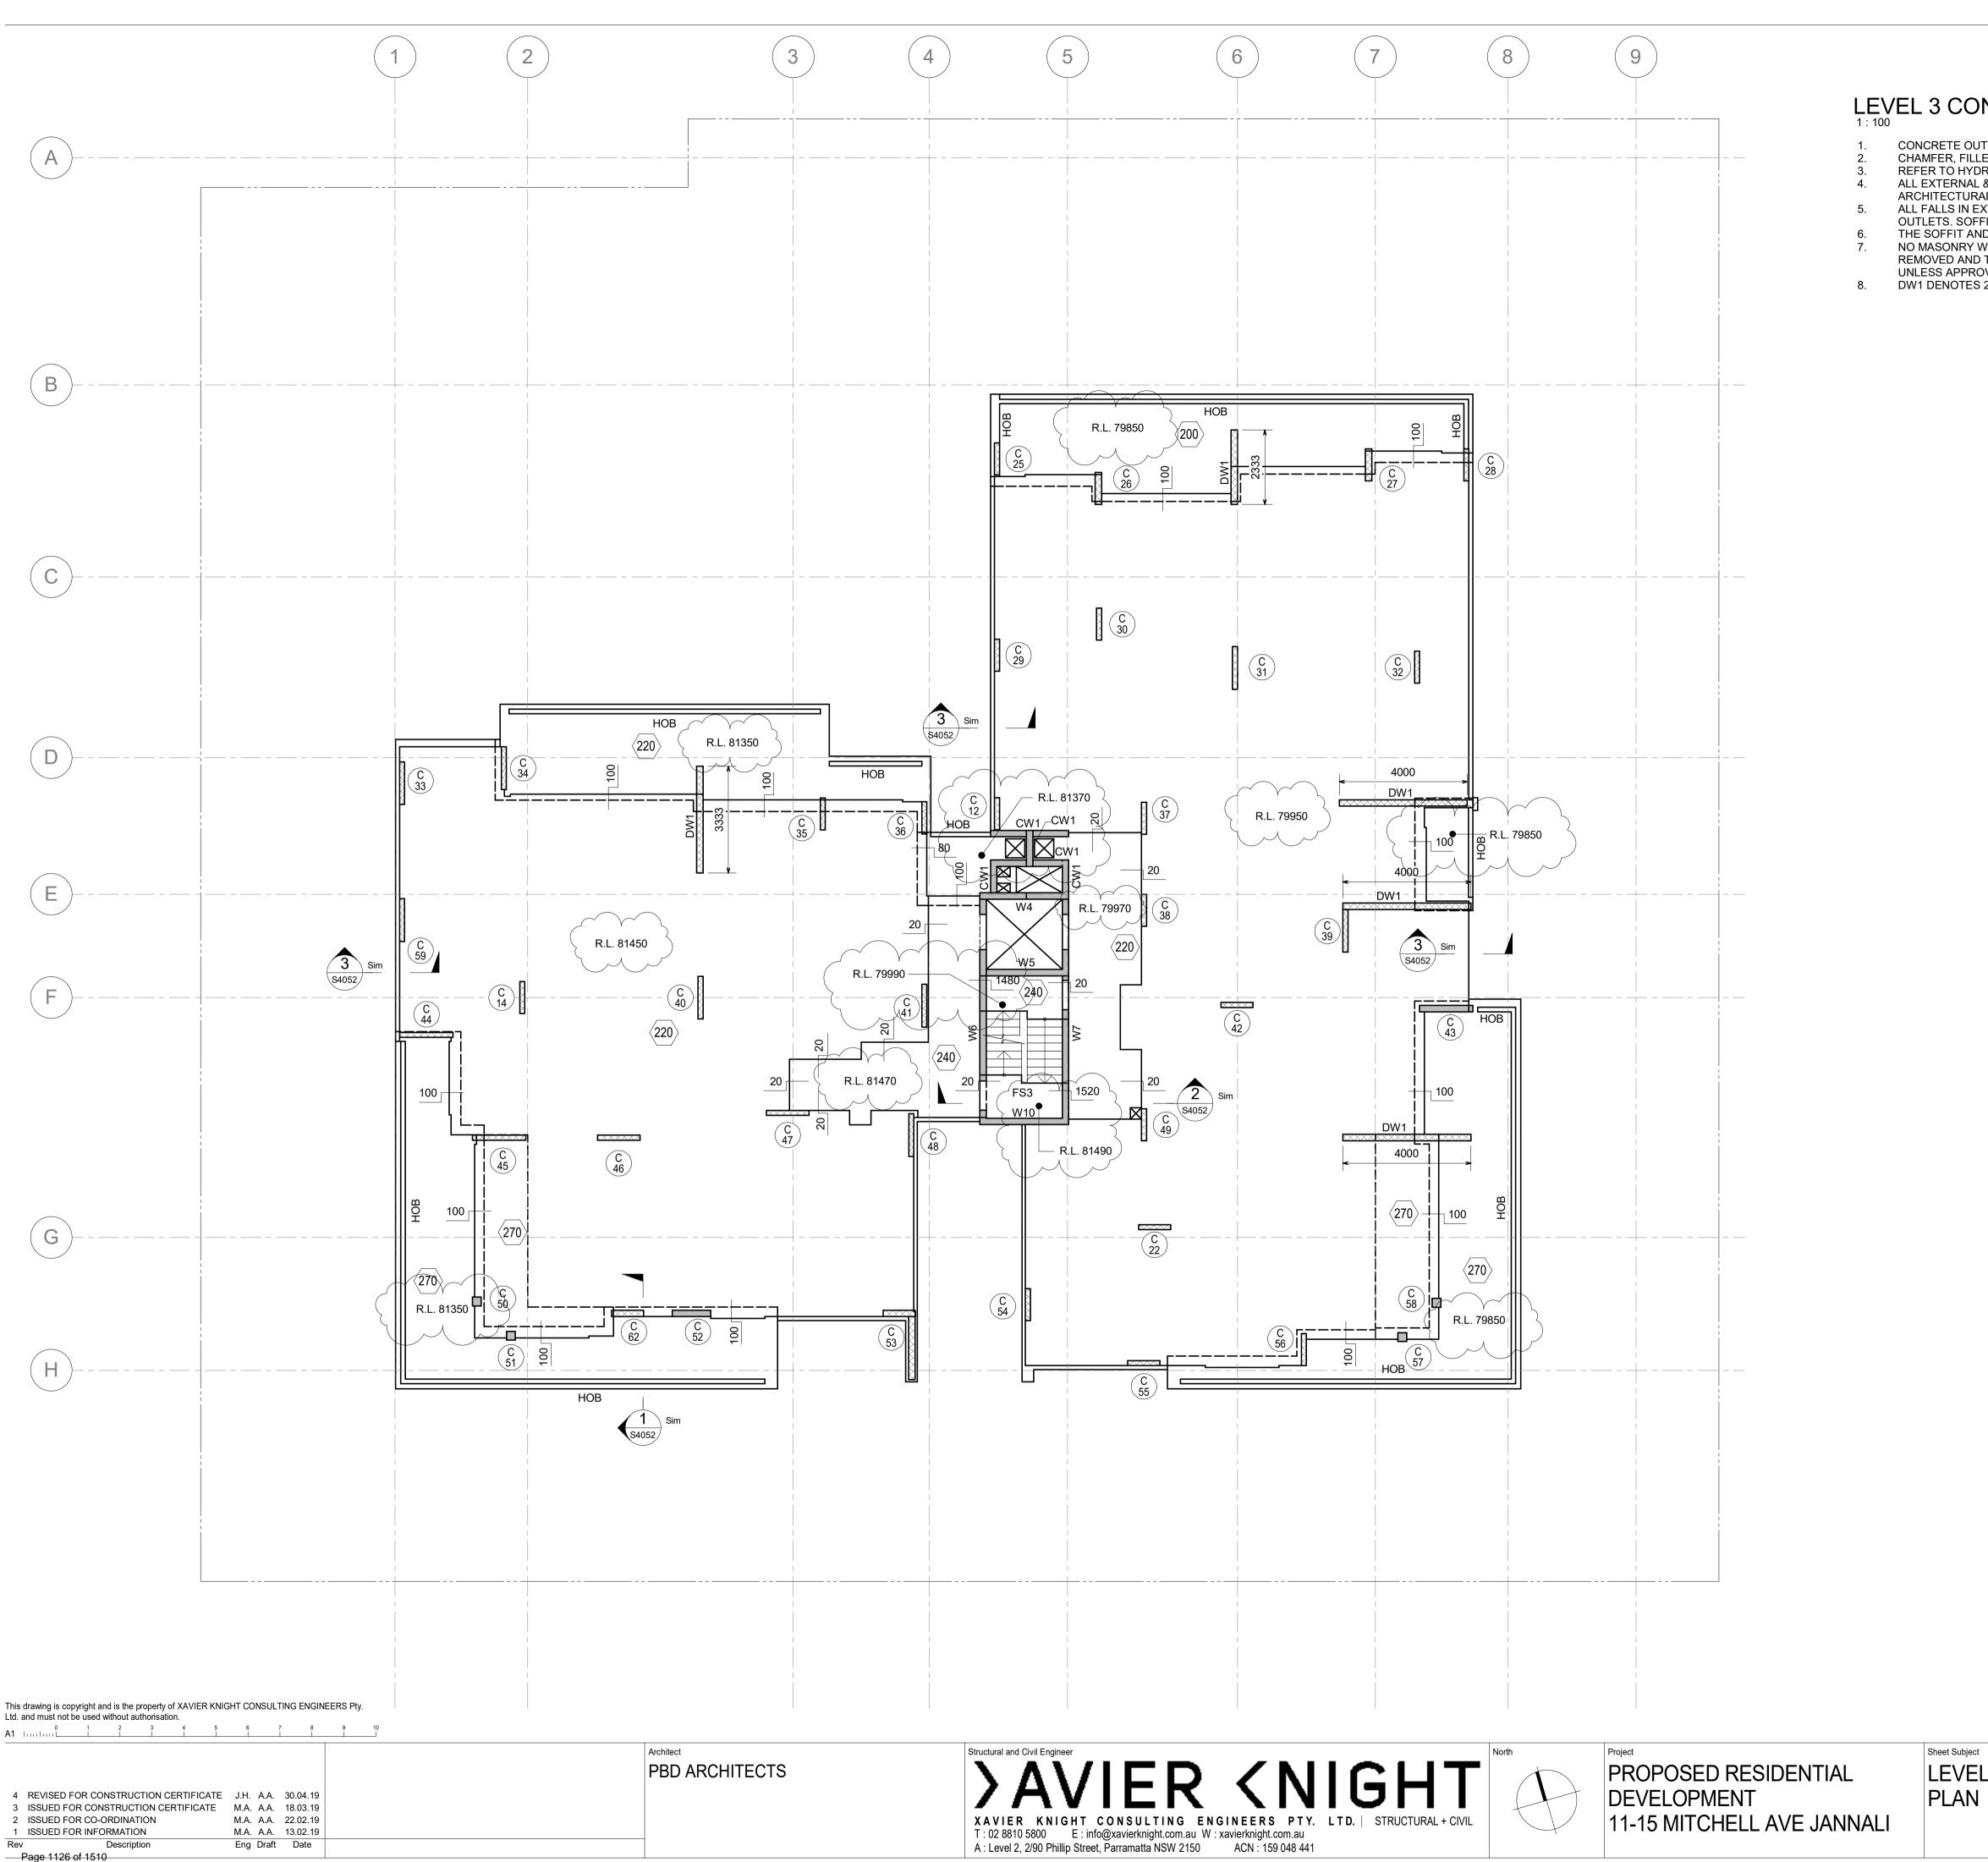
Job No

Drawn AA

Drawing No

S2001

Revisior



LEVEL 3 CONCRETE OUTLINE PLAN - 200 THICK SLAB U.N.O.

CONCRETE OUTLINES, LEVELS, SETDOWNS, REBATES, FALLS & PENETRATIONS TO ARCHITECTS DETAILS. CHAMFER, FILLET AND DRIP GROOVES TO ARCHITECT DETAILS AND TO BUILDER REQUIREMENTS. REFER TO HYDRAULIC ENGINEER'S DRAWINGS FOR SUMPS, PITS AND GRATED DRAINS. ALL EXTERNAL & WET AREAS TO BE WATERPROOFED & INSULATED IN ACCORDANCE WITH THE ARCHITECTURAL SPECIFICATIONS

ALL FALLS IN EXTERNAL & WET AREAS TO BE MADE IN THE TOP OF STRUCTURAL SLAB TO HYDRAULIC OUTLETS. SOFFIT LAID FLAT. ENSURE MINIMUM CONCRETE THICKNESS ARE MAINTAINED. THE SOFFIT AND TOP OF STRUCTURAL SLABS ARE LAID TO FALLS. MAINTAIN MIN CONCRETE THICKNESS. NO MASONRY WALLS ARE TO BE CONSTRUCTED ON SUSPENDED LEVELS UNTIL THE SLAB PROPPING HAS BEEN REMOVED AND THE SLAB HAS ABSORBED ITS DEAD LOAD DEFLECTION. DO NOT REMOVE SLAB PROPPING UNLESS APPROVED BY THE ENGINEER. DW1 DENOTES 200 DINCEL WALL. REFER TO DRAWING S0412 FOR DETAILS.

> CONSTRUCTION CERTIFICATE NO. BCA/Certifiers 8899-01-2019-CC

DATE ISSUED: 10/05/2019

I certify that work completed in accordance with these plans and specification will comply with the regulations referred to in section 81A(5) of the Environmental Planning and Assessment Act 1979.

TRENTON JONES FOR AE&D ACCREDITATION NO. BPB0203



Scale at A1 1 : 100

Job No

Drawn AA

Drawing No

S3001

Approved JH

Revisior

181026



PLAN

LEVEL 4 CONCRETE OUTLINE PLAN - 200 THICK SLAB U.N.O.

CONCRETE OUTLINES, LEVELS, SETDOWNS, REBATES, FALLS & PENETRATIONS TO ARCHITECTS DETAILS. CHAMFER, FILLET AND DRIP GROOVES TO ARCHITECT DETAILS AND TO BUILDER REQUIREMENTS. REFER TO HYDRAULIC ENGINEER'S DRAWINGS FOR SUMPS, PITS AND GRATED DRAINS. ALL EXTERNAL & WET AREAS TO BE WATERPROOFED & INSULATED IN ACCORDANCE WITH THE

ALL FALLS IN EXTERNAL & WET AREAS TO BE MADE IN THE TOP OF STRUCTURAL SLAB TO HYDRAULIC OUTLETS. SOFFIT LAID FLAT. ENSURE MINIMUM CONCRETE THICKNESS ARE MAINTAINED. THE SOFFIT AND TOP OF STRUCTURAL SLABS ARE LAID TO FALLS. MAINTAIN MIN CONCRETE THICKNESS. NO MASONRY WALLS ARE TO BE CONSTRUCTED ON SUSPENDED LEVELS UNTIL THE SLAB PROPPING HAS BEEN REMOVED AND THE SLAB HAS ABSORBED ITS DEAD LOAD DEFLECTION. DO NOT REMOVE SLAB PROPPING

DW1 DENOTES 200 DINCEL WALL. REFER TO DRAWING S0412 FOR DETAILS.



DATE ISSUED: 10/05/2019

I certify that work completed in accordance with these plans and specification will comply with the regulations referred to in section 81A(5) of the Environmental Planning and Assessment Act 1979.

TRENTON JONES FOR AE&D ACCREDITATION NO. BPB0203

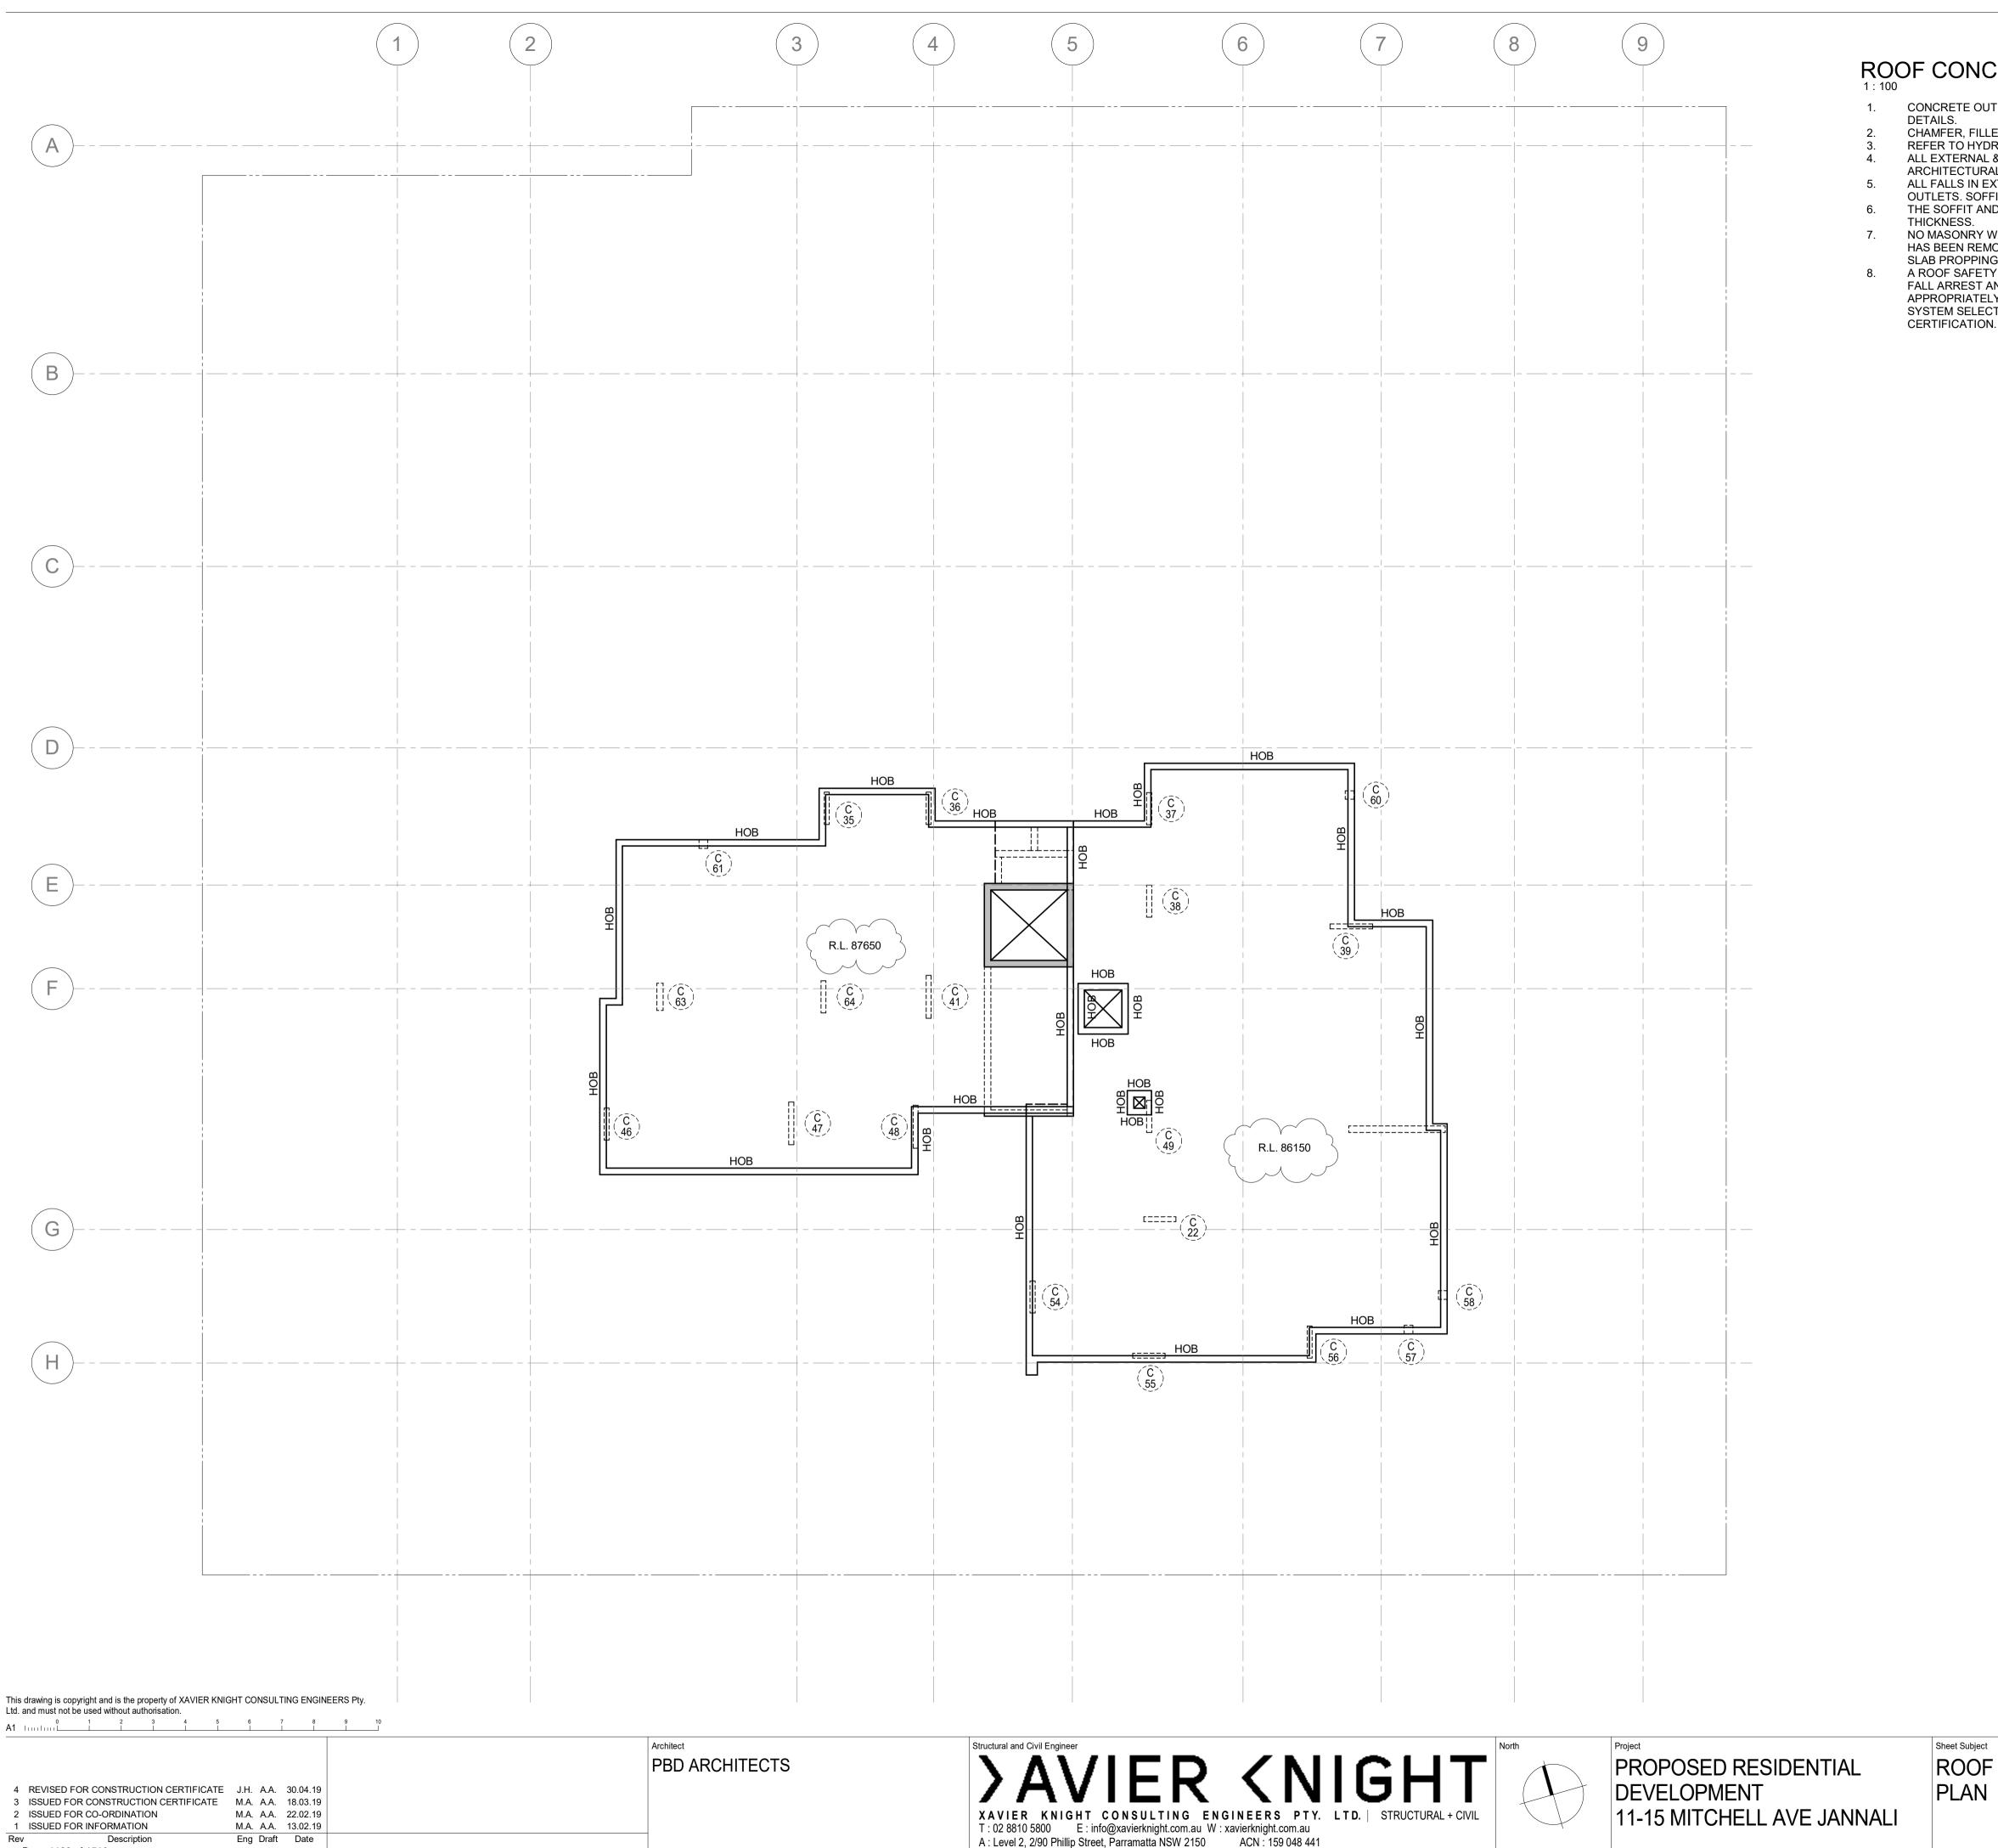


Scale at A1
1:100

Drawn AA

Job No 181026 Drawing No S4001 Approved

Revisior



ROOF CONCRETE OUTLINE PLAN - 200 THICK SLAB U.N.O.

CONCRETE OUTLINES, LEVELS, SETDOWNS, REBATES, FALLS & PENETRATIONS TO ARCHITECTS

CHAMFER, FILLET AND DRIP GROOVES TO ARCHITECT DETAILS AND TO BUILDER REQUIREMENTS. REFER TO HYDRAULIC ENGINEER'S DRAWINGS FOR SUMPS, PITS AND GRATED DRAINS. ALL EXTERNAL & WET AREAS TO BE WATERPROOFED & INSULATED IN ACCORDANCE WITH THE ARCHITECTURAL SPECIFICATIONS

ALL FALLS IN EXTERNAL & WET AREAS TO BE MADE IN THE TOP OF STRUCTURAL SLAB TO HYDRAULIC OUTLETS. SOFFIT LAID FLAT. ENSURE MINIMUM CONCRETE THICKNESS ARE MAINTAINED. THE SOFFIT AND TOP OF STRUCTURAL SLABS ARE LAID TO FALLS. MAINTAIN MIN CONCRETE

NO MASONRY WALLS ARE TO BE CONSTRUCTED ON SUSPENDED LEVELS UNTIL THE SLAB PROPPING HAS BEEN REMOVED AND THE SLAB HAS ABSORBED ITS DEAD LOAD DEFLECTION. DO NOT REMOVE SLAB PROPPING UNLESS APPROVED BY THE ENGINEER.

A ROOF SAFETY ACCESS SYSTEM WHICH COMPLIES WITH THE RELEVANT OH & S REGULATIONS FOR FALL ARREST AND THE RELEVANT AUSTRALIAN STANDARDS IS TO BE INSTALLED AND CERTIFIED BY AN APPROPRIATELY EXPERIENCED SPECIALIST SUPPLIER. THE DESIGN BY THE SPECIALIST IS TO INCLUDE SYSTEM SELECTION, LAYOUT, INSTALLATION, FLASHING, STRENGTHENING WORKS AND



DATE ISSUED: 10/05/2019

I certify that work completed in accordance with these plans and specification will comply with the regulations referred to in section 81A(5) of the Environmental Planning and Assessment Act 1979.

TRENTON JONES FOR AE&D ACCREDITATION NO. BPB0203

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181026

Job No

Drawn AA

Drawing No

S5001

Approved

Revision

NOTICE TO COMMENCE BUILDING WORK & OF A PRINCIPAL CERTIFYING AUTHORITY (PCA)

This form is used to:

- Notify the council that you intend to commence building work
- Notify the council and the authority that granted development consent of a complying development certificate that you have appointed a principal certifying authority

1. DETAILS OF THE APPLICANT / HOLDER OF THE DEVELOPMENT CONSENT

Note: This application must be made by the person having benefit of the development consent. It may not be made by any contractor or other person who will carry out the building work unless the contractor or other person is the owner of the land on which the work is to be carried out.

mr () ms	○ MRS ○ DR ○ COMPANY ● OTHER ○
APPLICANT	Truland Pty. Ltd.
ADDRESS	Suite 300 105 Sussey Street

	Suite 309 405 Sussex Sti	eel			
SUBURB	Sydney	STATE	NSW	POSTCODE	2000
TELEPHONE	02 8542 0459	MOBILE	0433 959 418	EMAIL a	albert@truland.com.au

2. DETAILS OF THE LAND TO BE DEVELOPED

ADDRESS 11 - 15 Mitchell Avenue						
SUBURB	Jannali	STATE NSW		POSTCODE 2226		
LOT NO.		DP/MPS NO.	1250463			
SECTION		VOLUME/FOLI	0			

3. DESCRIPTION OF THE WORK PROPOSED

TYPE OF WORK PROPOSED:	V BUILDING	SUBDIVISION
------------------------	-------------------	-------------

DESCRIPTION OF THE WORK:

Construction of a five storey residential unit building over two levels of car park, containing 31 units.



BCA / Certifiers

4. DETAILS OF THE DEVELOPMENT CONSENT

DEVELOPMENT APPLICATION NO. 18/0393

CONSENT AUTHORITY

Sutherland Shire Council

SECTION 96 MODIFICATION

DATE THE CONSENT WAS GRANTED 20 November 2018

OR

1

COMPLYING DEVELOPMENT CERTIFICATE NO.

DATE THE CERTIFICATE WAS ISSUED

CONSENT AUTHORITY

5. DETAILS OF THE CONSTRUCTION CERTIFICATE (if applicable)

CONSTRUCTION CERTIFICATE NO. 8899-01-2019-CC

date the certificate was issued 10/05/19

6. STEPS TAKEN BY THE APPLICANT

INDICATE THE STEPS YOU HAVE TAKEN BY PLACING A CROSS IN EACH BOX.

I have met all the conditions in the development consent or the complying development certificate required to be satisfied before I can begin work

I have appointed a principal certifying authority

NAME OF THE PRINCIPAL CERTIFYING AUTHORITY Trenton Jones , for AED

SUBURB Pyrmont					
,		STATE	NSW	POSTCODE	2009
telephone 02-9571 8433	MOBILE	0430 754 888	EM	AIL trenton@aedconsultin	ng.com.au

WHERE THE PRINCIPAL CERTIFYING AUTHORITY IS AN ACCREDITED CERTIFIER:

ACCREDITATION BODY OF THE CERTIFIER Department of Planning - Building Professionals Board

ACCREDITATION NO. OF THE CERTIFIER BPB0203



7. RESIDENTIAL BUILDING WORK / PRINCIPAL CONTRACTOR DETAILS

1. Is the subject development a residential building with no more than 3 above ground storeys? Do not complete this section. ΝO YES Please complete Part 2 below 2. Are you an owner builder? What is your owner-builder permit No.? YES Will the work be carried out by someone who is licensed to do so? ΝO IF YES BUILDER'S NAME Lords Group BUILDER'S ADDRESS Level 7, 80 George St, Parramatta 9191 0622 TELEPHONE NO. 290914C CONTRACTOR LICENCE NO.

3. Have you attached to this notice, evidence that the licensed person is insured to carry out this type of work (i.e. a copy of an Owner Builder Permit or Builder's Home Warranty Insurance Certificate)?

IF NO Have you attached to this notice, a declaration (signed by the land owner/s) that the reasonable market cost of the labour and materials to be used is less that \$1000?

8. DATE THE WORK WILL COMMENCE

YES

NO

date 14/05/19

NOTE: YOU MUST PROVIDE AT LEAST 2 DAYS NOTICE



Page 1131 of 1510

Mitchell Ave Developments P/L vs	s Forte Sydney Construction	s P/L
	Report issued: 25 February	2022

BCA / Certifier

9. SIGNATURE

SIGNATURE	\$+3A2	DATE 19-Feb-2019	
NAME	Hengyu Zhang		

NOTE: THE BUILDING CONTRACTOR CANNOT SIGN THIS FORM UNLESS THEY ARE ALSO THE OWNER OF THE LAND

Section 109E of the Environmental Planning & Assessment Act 1979, states:

(1) The person having the benefit of a development consent or complying development certificate for development involving building work or subdivision work may appoint the consent authority, the council or an accredited certifier as the principal certifying authority for the development.

(1A) Despite subsection (1), such an appointment may not be made by any contractor or other person who will carry out the building work or subdivision work unless the contractor or other person is the owner of the land on which the work is to be carried out.

THE PRINCIPAL CERTIFYING AUTHORITY MUST SIGN THE NOTICE.

I confirm that all conditions of the above development consent that are required to be satisfied prior to the work commencing have been satisfied.

I consent to being appointed by the applicant to carry out the role of the Principal Certifying Authority for this development.

NAME Trenton Jones

date 10/05/19

SIGNATURE

10. PRIVACY POLICY

The information you provide in this notice is required under the Environmental Planning and Assessment Act 1979 if you are going to erect a building or carry out subdivision work. If you do not provide the information to the consent authority, you cannot commence the work. The information will be held by the consent authority and by the council (if the council is not the consent authority). Please contact the council if the information you have provided in this notice is incorrect or changed.



CONSTRUCTION CERTIFICATE

NO. 8899-01-2019-CC

10 May 2019



Issued under Part 4A, Section 109C of the Environmental Planning and Assessment Act 1979

APPLICANT DETAILS

APPLICANT Truland Development Pty Ltd

A D D R E S S Suite 309, 405 Sussex Street, SYDNEY NSW 2000

MOBILE 0417 113 188 EMAIL kyrad@cpdm.com.au

OWNER DETAILS

NAME OF OWNER Michell Avenue Development

ADDRESS Suite 309, 405 Sussex Street, SYDNEY NSW 2000

DATE APPLICATION RECEIVED 26/04/2019

RELEVANT CONSENTS

EVELOPMENT APPLICATION	DA18/0393	DATE ISSUED	20/11/2018

CONSENT AUTHORITY Sutherland Shire Council

PROPOSAL

ADDRESS	11-1	5 Mitchell Av	enue, JANI	VALI NSW 2226				
LOT NO.	2			DP NO	206541			
	1				210456			
	М				415456			
BUILDING	CLASSIFI	CATION	Class 2 & 3	7a				
DESCRIPT		ge 1 – Exca els of basen	,	ing and complete king.	structure only for	a 5 storey res	idential flat bu	ilding over 2
		els of basen	nent car par	0	structure only for	a 5 storey res	idential flat bu	ilding over 2
VALUE OF	lev	ction (IN	ent car par C GST)	king.	structure only for	a 5 storey res	idential flat bu	ilding over 2
A P P R O V E I	lev Constru	CTION (IN SPECIFIC	C GST)	king. \$10,150,000.00	structure only for	a 5 storey res	idential flat bu	ilding over 2

ALTERNATIVE SOLUTION REPORT/S

TITLE	DATE	REFERENCE & REVISION	REPORT PREPARED BY	ACCREDITATION NO
Fire Engineering Report	09/05/19	138309 FER001b	Sarnia Rusbridge – Holmes Fire	BPB0722





CRITICAL STAGE INSPECTIONS <u>See attached notice</u>

CERTIFIER DETAILS

CERTIFYING AUTHORITY	Trenton Jones
ACCREDITATION DETAILS	Building Professionals Board BPB0203 - A1 Unrestricted

DETERMINATION

APPROVAL DATE 10 May 2019

I confirm that work completed in accordance with the documentation accompanying the application for this certificate (with such modifications, if any, verified by me as may be shown on that documentation) will comply with the requirements of the Environmental Planning & Assessment Regulation 2000 as referred to in s.81A(5) of the Environmental Planning & Assessment Act 1979.

Trenton Jones





SCHEDULE 1 - APPROVED PLANS & SPECIFICATIONS

Plans issued by Xavier Knight Consulting Engineers:

No.	Title	Drawing No.	Revision	Date
1.	Basement Level B2 Concrete Outline Plan	S0701	4	30/04/19
2.	Basement Level B1 Concrete Outline Plan	S0801	4	30/04/19
З.	Ground Floor Concrete Outline Plan	S0901	4	30/04/19
4.	Level 1 Concrete Outline Plan	S1001	4	30/04/19
5.	Level 2 Concrete Outline Plan	S2001	4	30/04/19
6.	Level 3 Concrete Outline Plan	S3001	4	30/04/19
7.	Level 4 Concrete Outline Plan	S4001	4	30/04/19
8.	Roof Concrete Outline Plan	S5001	4	30/04/19





022

SCHEDULE 2 - SUPPORTING DOCUMENTATION

No.	Title	Prepared by	Reference	Date
1.	Construction Certificate Application Form	Truland Development Pty Ltd	-	09/04/19
2.	Long Service Levy Receipt	Long Service Corporation	370260	21/02/19
З.	Existing Underground Services Plans	Dial Before You Dig	15437251	10/12/18
4.	Tap In Building Plan Approval	Sydney Water	3970412	31/01/19
5.	Section 73 Notice of Requirements	Sydney Water	175866	21/02/19
6.	Design Certificate - Shoring & Excavation	Xavier Knight Consulting Engineers	181026	06/03/19
7.	Shoring Plans	Xavier Knight Consulting Engineers	181026	-
	Title	Drawing No.	Revision	Date
	Cover Sheet	S0000	2	15/03/19
	Notes Sheet	S0001	2	15/03/19
	Shoring & Bulk Excavation Plan	S0101	2	15/03/19
	Shoring Wall Elevations Sheet 1	S0111	2	15/03/19
	Shoring Wall Elevations Sheet 2	S0112	2	15/03/19
	Shoring Wall Sections Sheet 1	S0115	2	15/03/19
	Shoring Wall Details Sheet 1	S0121	2	15/03/19
	Shoring Wall Details Sheet 2	S0122	2	15/03/19
8.	Design Certificate - Structural	Xavier Knight Consulting Engineers	181026	30/04/19
9.	Structural Plans	Xavier Knight Consulting Engineers	181026	-
0.	Title	Drawing No.	Revision	Date
	Cover Sheet	S0000	2	15/03/19
	Notes Sheet	S0001	2	15/03/19
	Footing Plan	S0201	1	15/03/19
	Footing Details Sheet 1	S0211	1	15/03/19
	Column Schedule Sheet 1	S0301	1	15/03/19
	Column Schedule Sheet 2	S0302	2	15/03/19
	Column Details Sheet 1	S0311	1	15/03/19
	Wall Elevations Sheet 1	S0401	1	15/03/19
	Wall Elevations Sheet 2	S0402	1	15/03/19
	Wall Details Sheet 1	S0411	1	15/03/19
	Wall Details Sheet 2	S0412	1	15/03/18
	Stair Details Sheet 1	S0501	1	15/03/18
	Basement Level B2 Details	S0751	1	15/03/19
	Basement Level B1 Details Sheet 1	S0851	1	15/03/19
	Basement Level B1 Details Sheet 2	S0852	1	15/03/19
	Ground Floor Sections and Details Sheet	S0951	1	15/03/19
	Ground Floor Sections and Details Sheet 2	S0952	1	15/03/19
	Ground Floor Sections and Details Sheet 3	S0953	1	15/03/19
	5	· · · · · · · · · · · · · · · · · · ·		
	Level 1 to 4 Typical Details	S4051	1	18/03/19




				BCA / Certifiers
No.	Title	Prepared by	Reference	Date
10.	Design Certificate - Civil Works	Xavier Knight Consulting Engineers Pty Ltd	181026	-
11.	Civil Works Plans	Xavier Knight Consulting Engineers Pty Ltd	181026	-
	Title	Drawing No.	Revision	Date
	Cover Sheet	C000	A	18/04/19
	Stormwater Management Plan Basement 02	C100	А	18/04/19
	Stormwater Management Plan Basement 01	C101	А	18/04/19
	Stormwater Management Plan Ground Floor	C102	а	18/04/19
	OSD Tank Outlet Pipe Longitudinal Section	C103	А	18/04/19
	Drainage Details Sheet 1 of 3	C200	A	18/04/19
	Drainage Details Sheet 2 of 3	C201	A	18/04/19
	Drainage Details Sheet 3 of 3	C202	A	18/04/19
	Sediment and Erosion Control Plan	C300	A	18/04/19
	Sediment and Erosion Control Details	C301	A	18/04/19
	Driveway Plan	C400	A	18/04/19
	Driveway Longitudinal Section	C401	A	18/04/19
	Public Domain General Arrangement Plan	C500	А	18/04/19
	Public Domain Set-out Plan	C501	A	18/04/19
	Public Domain Details	C510	A	18/04/19
12.	Design Certificate - Fire Hydrants	Scott Collis Consulting Pty Ltd	-	04/04/19
13.	Fire Engineering Report	Holmes Fire Pty Ltd	138309 FER001b	09/05/19
14.	Condition 2 – Council Security Bond Receipt	Truland Development	N020899309719	08/02/19
15.	Condition 3 – S94 Constructions Receipt	Sutherland Shire Council	857270	29/04/19
16.	Condition 5 – Detailed Frontage Works Application Receipt	Sutherland Shire Council	853208	20/02/19
17.	Development Frontage Works Design Brief	Sutherland Shire Council	RDA19/0189	27/02/19
18.	Alignment Levels Application Receipt	Sutherland Shire Council	-	31/01/19
19.	Condition 6 – Site Management Plan	Lords Group	Rev 1.0	30/01/19
20.	Condition 8 – Supervising Engineer Contact Details	Lords Group	-	04/03/19
21.	Condition 9 & 10 – Vehicular Access and Car Parking Design Certificate	Varga Traffic Planning pty Ltd	18790	10/04/19
22.	Condition 14 – Email re: Condition Satisfied	JK Geotechnics	-	12/02/19
23.	Condition 14 – Geotechnical Investigation Report	JK Geotechnics	30251Srpt	21/03/17
24.	Condition 16 – Registered Plan of Consolidation	NSW Land Registry Services	DP1250463	22/02/19
25.	Condition 21 – Car Wash Bay Design Compliance Statement	Scott Collis Consulting Pty Ltd	-	26/03/19



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Page 1137 of 1510 CERTIFICATE NUMBER: 8899-01-2019-CC

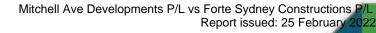

		-		BCA / Certifiers
No.	Title	Prepared by	Reference	Date
26.	Condition 29 – Dilapidation Report - 17 Mitchell Avenue	Xavier Knight Consulting Engineers	181026	29/01/19
27.	Condition 29 – Dilapidation Report - 43 Oxley Avenue	Xavier Knight Consulting Engineers	181026	29/01/19
28.	Condition 29 – Dilapidation Report - Council Infrastructure (Mitchell Ave)	Xavier Knight Consulting Engineers	181026	29/01/19
29.	Condition 29 – Dilapidation Report - Council Infrastructure (Oxley Ave)	Xavier Knight Consulting Engineers	181026	29/01/19
30.	Condition 31 – SEPP 65 Verification Statement	PBD Architects & Project Managers Pty Ltd	-	March 2019
31.	Record of Inspection - Pre CC	Trenton Jones (AED)	8899	02/05/19



Page 6 of 12



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SCHEDULE 3 - FIRE SAFETY SCHEDULE

ADDRESS: 11-15 Mitchell Avenue, JANNALI NSW 2226

PERFORMANCE BASED ALTERNATIVE SOLUTION: YES \Box

RELEVANT BCA VOLUME: BCA 2016 Amendment 1

ESSENTIAL SERVICE	INSTALLATION	NATURE OF INSPECTION OR	Existing	Proposed
TO BE INSPECTED OR TESTED	STANDARDS/LEVEL OF PERFORMANCE	TEST & FREQUENCY (for information only)	Tick as ap	opropriate
General - Fire Resistance Fire-resisting Structures & Exits	BCA Sections C & D & Fire Engineering Report prepared by Homes Fire, ref: 138309.FER001b, Ver B, dated 09/05/19	Annual inspection		
Lightweight Construction	BCA Clause C1.8, BCA Specification C1.8	Annual inspection		
Fire-rated (or non- combustible) Access Panels, Doors & Hoppers to Fire- resisting Shafts	BCA C3.13	To AS1851-2012		
Fire Seals protecting openings in Fire-resisting components of the building (including Fire Collars & Fire-stopping/Mastic)	BCA Clause C3.15, BCA Specification C3.15 & C3.16, AS1530.4-2014	Annual inspection		
Fire-rated Lift Landing Doors	BCA Part Clause C3.10, AS1735.11-1986	To AS1851-2012		\boxtimes
Fire Doors	BCA Part C3, BCA Specification C3.4 (Clause 2), AS1905.1-2015	To AS1851-2012		
Fire Shutters	BCA Clause C3.5, Specification C3.4 & Fire Engineering Report prepared by Homes Fire, ref: 138309.FER001b, Ver B, dated 09/05/19	To AS1851-2012		
Fire Dampers	BCA Clause C3.15, AS/NZS 1668.1-2015 AS1682.1-2015 AS1682.2-2015	To AS1851.1		
General - Egress				
Paths of Travel	BCA Clause 186 EP&A Regulation 2000, BCA Section D	Monthly inspections to confirm exit doors are accessible, intact, operational & fitted with conforming hardware		
Warning & Operational Signs	Fire & Smoke Door Signage - BCA Clause D2.23 Offences relating to Fire Stairs - Clause 183 of EP&A Regulation 2000 & Engineering Report prepared by Homes Fire, ref: 138309.FER001b, Ver B, dated 09/05/19	Annual inspection		
General - Services & Equipme				
Portable Fire Extinguishers	BCA Clause E1.6, AS2444-2001	To AS1851-2012		



AE&D Pty Ltd A: Suite 3.04, 55 Miller Street, Pyrmont NSW 2009 Southern Highlands A: Unit 10, 19 Lyell Street, Mittagong NSW 2575 Sutherland Shire A: Suite 20, Level 1 Regus, 29 Kiora Road, Miranda NSW 2228 Harper, Burloy 271, 2433, E: admin@aedconsulting.com.au Harper, W: www.aecconsulting.com.au ABN: 75149 587 495

Page 1139 of 1510 CERTIFICATE NUMBER: 8899-01-2019-CC

				BCA / Certifiers
ESSENTIAL SERVICE TO BE INSPECTED OR	INSTALLATION STANDARDS/LEVEL OF	NATURE OF INSPECTION OR	Existing	Proposed
TESTED	PERFORMANCE	TEST & FREQUENCY (for information only)	Tick as a	opropriate
Warning Systems associated with Lifts (including Signs)	BCA Part E3	Annual inspection		\boxtimes
Mechanical Services				
Air-conditioning & Mechanical Ventilation/Air Handling Systems	BCA Clause E2.2, BCA Table E2.2a, BCA NSW Table E2.2b, AS1668.1-2015, AS1668	To AS1851-2012		
Electrical Services				
Automatic Fire Detectors & Alarm Systems including heat detectors	BCA Clause E2.2 (Clauses 3,4, 6), BCA Table E2.2a, BCA Specification E2.2a, AS1670.1-2015 & AS3786-2014 & Fire Engineering Report prepared by Homes Fire, ref: 138309.FER001b, Ver B, dated 09/05/19	To AS1851-2012		
Emergency Lighting	BCA E4.2, E4.4 & AS2293.1-2005	To AS 2293.2		
Exit Signs	BCA E4.5, E4.6, E4.8, AS2293.1-2005 & Engineering Report prepared by Homes Fire, ref: 138309.FER001b, Ver B, dated 09/05/19	To AS 2293.2		
Hydraulic Services				
Fire Hydrants	BCA Clause E1.3, AS2419.1-2005 & Fire Engineering Report prepared by Homes Fire, ref: 138309.FER001b, Ver B, dated 09/05/19	To AS1851-2012		
Fire Hose Reel Systems	BCA Clause E1.4 & AS2441-2005	To AS1851-2012		\boxtimes
Fire Engineering Report				
Performance Solution 1 – FRL of Fire Rated Shutter The basement levels are to be separated into two fire compartments. Openings in fire walls are to be protected by doors that achieve an FRL of -/120/30. The proposed fire shutter will achieve an FRL of - /120/	 Fire Engineering Report prepared by Homes Fire, ref: 138309.FER001b, Ver B, dated 09/05/19 The Shutter shall abut 120/120/120 fire rated construction and be sealed/fire stopped against the spread of fire, and a blade wall (- /120/120 FRL) is to extend to the east of the southern column on Basement Level 1. Smoke detector to be provided on the ceiling within 1.5m of both sides of the fire shutter, Automatic closing of the carpark shutter is to be inititated by activation of smoke detector, any heat detector in the basement carpark and power failure. An audible 	To AS1851-2012		

Page 1140 of 1510 CERTIFICATE NUMBER: 8899-01-2019-CC

				BCA / Certifiers
ESSENTIAL SERVICE TO BE INSPECTED OR	INSTALLATION STANDARDS/LEVEL OF	NATURE OF INSPECTION OR TEST & FREQUENCY	Existing	Proposed
TESTED	 PERFORMANCE warning device must be located near the shutter and a red flashing warning light of adequate intensity must be installed on each side of the doorway Hatched line marking is to be provided to the floor surface on either side of the carpark fire shutter. These markings are to extend not less than 2.8 m out from the shutter. Signage within the hatching is to state "KEEP CLEAR. NO PARKING. NO STORAGE'. The lettering is to be in capitals, no less than 100 mm in height and in a colour contrasting with the background. The requirement to prohibit storage and parking is to be included in the strata by-laws. 	TEST & FREQUENCY (for information only)	Tick as ap	propriate
Performance Solution 2 – Residential Travel Distance The maximum travel distance from the entry door of a residential SOU to an exit is permitted to be 6 m. The travel distance from SOU 106, 206 and 306 is 6.25 m measured door leaf to door leaf.	 Fire Engineering Report prepared by Homes Fire, ref: 138309.FER001b, Ver B, dated 09/05/19 The public corridors will be provided with internally illuminated exit and direction signs in accordance with BCA Part E4 and AS 2293.1- 2005. The Concession within BCA Clause E4.7 is not to be applied. Security screen doors are not to be permitted to any of the SOU entry doors. 	To AS1851-2012		
Performance Solution 3 – Travel Distance in Basement Carpark The maximum travel distance in the basement carpark is permitted to be 20 m to a point of choice of exits and 40 m to an exit where two or more exits are available. The travel distance from the northwest corner of Basement Levels 1 and 2 is up to 30 m to a point of choice and 39 m to the nearest exit.	 Fire Engineering Report prepared by Homes Fire, ref: 138309.FER001b, Ver B, dated 09/05/19 Heat detection to be provided to the requirements of AS 1670.1-2015 to activate the carpark ventilation system (as per Clause 5 of AS/NZS 1668.1-2015) The stairs serving the basement are to be fire separated from the carpark on both levels with bounding construction achieving 	To AS1851-2012		



Page 1141 of 1510 CERTIFICATE NUMBER: 8899-01-2019-CC

			0.004	BCA / Certifiers
ESSENTIAL SERVICE TO BE INSPECTED OR	INSTALLATION STANDARDS/LEVEL OF	NATURE OF INSPECTION OR TEST & FREQUENCY	Existing	Proposed
TESTED	PERFORMANCE an FRL of not less than - /120/120. Doors into the stair are to be self closing fire rated doorsets achieving an FRL of not less than - /120/30.	(for information only)	Tick as ap	propriate
Performance Solution 4 – Discharge of Residential Fire-Isolated Stair				
Fire-isolated stairs are required to discharge to a road, open space, or a covered area with a ceiling height of at least 3 m and open for 1/3 of the perimeter. Fire-isolated stair FS3 discharges into a covered area that is open for 36 % of the perimeter with a ceiling height of 2.4 m and a distance of 1.2 m to open space.	Fire Engineering Report prepared by Homes Fire, ref: 138309.FER001b, Ver B, dated 09/05/19	To AS1851-2012		
Performance Solution 5 – Fire Hydrant Booster Location The building is required to be provided with a fire hydrant system in accordance with AS 2419.1-2005, which includes a fire brigade booster connection. A remote booster is required to be located at least 10 m from the building. The proposed booster will be located in the southeast corner of the property, 9 m from the building.	 Fire Engineering Report prepared by Homes Fire, ref: 138309.FER001b, Ver B, dated 09/05/19 The walls to Unit G04 and 104 are to achieve an FRL of at least - /90/90 in both directions and the balustrade to Unit 104 is to be concrete for a height of at least 760mm. 	To AS1851-2012		
Performance Solution 6 – Hydrant System Design The building is required to be provided with a hydrant system in accordance with AS 2419.1-2005. Due to the size of the carpark, the system is required to be designed based on two hydrants flowing, requiring a flow inquiry, a flow rate of 12 L/s can only be achieved. It is proposed to design the system based on a single hydrant flowing such that the provision of on-site water storage and pumps is not required.	 Fire Engineering Report prepared by Homes Fire, ref: 138309.FER001b, Ver B, dated 09/05/19 The hydrant system is to comply with AS 2419.1- 2005 other than it may be designed based on one hydrant flowing. Signage is to be provided at the booster and within the hydrant block plan provided near the FIP advising of the design pressures and flows of the system 	To AS1851-2012		





NOTICE TO APPLICANT OF MANDATORY CRITICAL STAGE INSPECTIONS

Made under Section 81A(2)(b1)(ii) of the Environmental Planning and Assessment Act 1979

		ant Dt. 1 tal		
APPLICANT	Truland Developm	ent Pty Lta		
A D D R E S S	Suite 309, 405 Sus	ssex Street, SYDNEY NSV	V 2000	
MOBILE	0417 113 188	EMAIL kyrad@cpd	dm.com.au	
RELEVAN	T CONSENTS			
DEVELOPME	NT APPLICATION	DA18/0393	DATE ISSUED	20/11/2018
CONSENT AU	THORITY Suth	erland Shire Council		
PROPOSA	L			
ADDRESS	11-15 Mitchell A	Avenue, JANNALI NSW 2	226	
LOT NO. 2		DP NO	206541	
BUILDING CI	ASSIFICATION	Class 2 & 7a		
SCOPE OF W		– Excavation, shoring and evels of basement car park		for a 5 storey residential flat building
CERTIFIE	R DETAILS			

CERTIFIING AUTHORITI	Trenton Jones
ACCREDITATION DETAILS	Building Professionals Board BPB0203 - A1 Unrestricted

I, Trenton Jones, of **AE&D Pty Ltd** located at Suite 3.04, 55 Miller St, Pyrmont, NSW 2009 acting as the principal certifier, hereby give notice in accordance with Section 109E (3) (d) of the Part 4 of the Environmental Planning and Assessment Regulation 2000-Reg 162A to the person having the benefit of the development consent, that the mandatory critical stage inspections identified in Schedule 1 overleaf are to be carried out in respect of the building work.

To allow a principal certifier or another certifying authority time to carry out mandatory critical stage inspections, the principal contractor for the building site, or the owner builder, must notify the principal certifier at least 48 hours before building work is commenced at the site if a mandatory critical stage inspection is required before the commencement of the work in accordance with Clause 162A of the Environmental Planning & Assessment Regulation 2000.

Failure to request a mandatory critical stage inspection will prohibit the principal certifier under Section 6.5 of the Environmental Planning and Assessment Act 1979 to issue an occupation certificate.

Dated: 10 May 2019

Trenton Jones Director





SCHEDULE 1: MANDATORY CRITICAL STAGE INSPECTIONS

No.	Critical Stage Inspection	Inspector
1.	First Footings After the commencement of the excavation for, and before the placement of, the first footing.	Certifying Authority
	Service Penetrations	
2.	Prior to covering of fire protection at service penetrations to building elements that are required to resist internal fire or smoke spread, inspection of a minimum of one of each type of protection method for each type of service, on each storey of the building comprising the building work.	Principal Certifier
	Bounding Wall Construction	
3.	Prior to covering the junction of any internal fire-resisting construction bounding a sole- occupancy unit (SOU), and any other building element required to resist internal fire spread, inspection of a minimum of 30% of SOUs on each storey of the building containing SOUs	Principal Certifier
	Waterproofing	
4.	Prior to covering of waterproofing in any wet areas, for a minimum of 10% of rooms with wet areas within a building. At least one unit is to be inspected.	Certifying Authority
5.	Stormwater	
0.	Prior to covering any stormwater drainage connections	Certifying Authority
	Final	
6.	After the building work has been completed and prior to any Occupation Certificate being issued in relation to the building	Principal Certifier



CONSTRUCTION CERTIFICATE

NO. 8899-02-2019-CC

25 June 2019



Issued under Part 4A, Section 109C of the Environmental Planning and Assessment Act 1979

APPLICANT DETAILS

APPLICANT Truland Development P/L

ADDRESS Suite 209, 405 Sussex Street, Sydney NSW 2000

TELEPHONE --- MOBILE 0417 113 188 EMAIL kyrad@cpdm.com.au

OWNER DETAILS

NAME OF OWNER Mitchell Avenue Development

ADDRESS Suite 309, 405 Sussex Street, Sydney NSW 2000

DATE APPLICATION RECEIVED 26/04/2019

RELEVANT CONSENTS

DEVELOPMENT APPLICATION	DA18/0393	DATE ISSUED	20/11/2018
	27.1.0,0000		

CONSENT AUTHORITY Sutherland Shire Council

PROPOSAL

ADDRESS 11-15 Mitchell Avenue, Jannali NSW 2226

LOT NO. 100

DP NO

BUILDING CLASSIFICATION 2, 7a, 7b

DESCRIPTION Construction of a five storey, 31 unit residential flat building over two levels of basement car parking

1250463

VALUE OF CONSTRUCTION (INC GST) \$10,150,000.00 (total cost of development)

APPROVED PLANS & SPECIFICATIONS Schedule 1

SUPPORTING DOCUMENTATION <u>Schedule 2</u>

FIRE SAFETY SCHEDULE <u>Schedule 3</u>

ALTERNATIVE SOLUTION REPORT/S

TITLE DATE		REFERENCE & REVISION	REPORT PREPARED BY	ACCREDITATION NO
Fire Engineering Report 09/05		138309 FER001b	Sarnia Rusbridge – Holmes Fire	BPB0722

CRITICAL STAGE INSPECTIONS <u>See attached notice</u>



CERTIFIER DETAILS

CERTIFYING AUTHORITY	Trenton Jones
ACCREDITATION DETAILS	Building Professionals Board BPB0203 - A1 Unrestricted

DETERMINATION

APPROVAL DATE 25 June 2019

I confirm that work completed in accordance with the documentation accompanying the application for this certificate (with such modifications, if any, verified by me as may be shown on that documentation) will comply with the requirements of the Environmental Planning & Assessment Regulation 2000 as referred to in s.81A(5) of the Environmental Planning & Assessment Act 1979.

Trenton Jones



SCHEDULE 1 - APPROVED PLANS & SPECIFICATIONS

Plans issued by PBD Architects (Project No.1747):

No.	Title	Drawing No.	Revision	Date
1.	Cover Sheet & BASIX Commitments	A0000	1	07/06/19
2.	BASIX Commitments	A0001	1	07/06/19
З.	Demolition Plan	A0002	1	07/06/19
4.	Materials Schedule	A0003	1	07/06/19
5.	Site Plan	A0004	1	07/06/19
6.	Wall Type Detail 01	A0201	1	07/06/19
7.	Basement Level 2 Plan	A1001	1	07/06/19
8.	Basement Level 1 Plan	A1002	1	07/06/19
9.	Ground Floor Plan	A1003	1	07/06/19
10.	Typical Level 1-3 Plan	A1004	1	07/06/19
11.	Level 4 Plan	A1005	1	07/06/19
12.	Roof Plan	A1006	1	07/06/19
13.	Concrete Setout Plan Basement Level 2	A1101	1	07/06/19
14.	Concrete Setout Plan Basement Level 1	A1102	1	07/06/19
15.	Concrete Setout Plan Ground Floor Plan	A1103	1	07/06/19
16.	Concrete Setout Plan Typical Level 1-3	A1104	1	07/06/19
17.	Concrete Setout Plan Level 4 Plan	A1105	1	07/06/19
18.	Concrete Setout Plan Level Roof Plan	A1106	1	07/06/19
19.	Wall Setout Basement Level 2 Plan	A1201	1	07/06/19
20.	Wall Setout Basement Level 1 Plan	A1202	1	07/06/19
21.	Wall Setout Ground Floor Plan	A1203	1	07/06/19
22.	Wall Setout Level 1-3 Plan	A1204	1	07/06/19
23.	Wall Setout Level 4 Plan	A1205	1	07/06/19
24.	RCP Ground Floor	A1303	1	07/06/19
25.	RCP Level 1-3	A1304	1	07/06/19
26.	RCP Level 4	A1305	1	07/06/19
27.	Elevation – South	A2001	1	07/06/19
28.	Elevation – West	A2002	1	07/06/19
29.	Elevation – North	A2003	1	07/06/19
30.	Elevation – East	A2004	1	07/06/19
31.	Section AA	A3001	1	07/06/19
32.	Section BB	A3003	1	07/06/19
33.	Section CC	A3002	1	07/06/19
34.	Section DD	A3004	1	07/06/19
35.	Section Details 01	A4001	1	07/06/19
36.	Section Details 02	A4002	1	07/06/19
37.	Balustrade Detail	A4101	1	07/06/19
38.	Threshold Detail	A4601	1	07/06/19
39.	Ceiling Floor Junction Detail	A4602	1	07/06/19
40.	Fire Stair 1 Detail	A4101	1	07/06/19
41.	Fire Stair 2 Detail	A4102	1	07/06/19
42.	Fire Stair 3 Detail	A4103	1	07/06/19



Mitchell Ave Developments P/L vs Forte Sydney Constructions P/L Report issued: 25 February 2022

No.	Title	Drawing No.	Revision	Date
43.	Window Schedule	A6001	1	07/06/19
44.	Door Schedule 01 / Door Jamb Detail	A6101	1	07/06/19
45.	Door Schedule 02	A6102	1	07/06/19
46.	Adaptable Layout Type A	A7001	1	07/06/19
47.	Adaptable Layout Type B	A7002	1	07/06/19
48.	Adaptable Layout Type C	A7003	1	07/06/19
49.	Kitchen Detail – Type A 3 Bed Units	A7101	1	07/06/19
50.	Kitchen Detail – Type B 2 Bed Units	A7102	1	07/06/19
51.	Kitchen Detail – Type C 1 Bed Units	A7103	1	07/06/19
52.	Wet Area Detail – Type A	A7201	1	07/06/19
53.	Wet Area Detail – Type B	A7202	1	07/06/19
54.	Wet Area Detail – Type C	A7203	1	07/06/19
55.	Typical Joinery Details	A7301	1	07/06/19
56.	Typical Laundry Details	A7302	1	07/06/19
57-62	Interior Finishes Schedule		В	07/06/19
63-70	Fixtures, Fittings and Hardware Schedule		В	07/06/19

Specification issued:

Title	Reference No.	Revision	Date
BCA Specification for 11-15 Mitchell Ave, Jannali			25/06/19



SCHEDULE 2 - SUPPORTING DOCUMENTATION

No.		Title		Prepared by	Prepared by	
1.	Con	nstruction Certificate Application Form	Truland Dev	uland Development P/L		
2.	SEF	PP 65 Design Verification Statement	PBD Archite	BD Architects & Project Managers P/L		March 2018
З.	Acc	ess Report No.19037, Issue B	Vista Access	s Architects P/L		26/05/19
4.	Nois	se Impact Assessment Report No.R180579R1, Rev 0	Rodney Stev	ens Acoustics F	?/L	27/05/19
5.	in C	ctrical Services Design Certificate – General Lighting Car Park / Wiring, Emergency Lighting, Spit Fires, & Fire	Tricom Engi	neering Group P	/L	21/05/19
6.	Elec	ctrical Design Certificate – External Lighting	Tricom Engil	neering Group P	/L	06/05/19
7.	Elec	ctrical Services Plans	Tricom Engil	neering Group P	/L	
		Title		Drawing No.	Revision	Date
	1.	Legend, Notes and Drawing Schedule		E01	С	21/05/19
	2.	Basement 02 Lighting, Dry Fire and Power Layout		E02	С	21/05/19
	З.	Basement 01 Lighting, Dry Fire and Power Layout		E03	С	21/05/19
	4.	Ground Floor Lighting and Dry Fire Layout		E04	С	21/05/19
	5.	Ground Floor Power and Communication Layout		E05	С	21/05/19
	6.	Typical Level 01 to 03 Lighting and Dry Fire Layout		E06	С	21/05/19
	7.	Typical Level 01 to 03 Power and Communication La	E07	С	21/05/19	
	8.	Level 04 Lighting and Dry Fire Layout	E08	С	21/05/19	
	9.	Level 04 Power and Communication Layout	E09	С	21/05/19	
	10.	Roof Level Layout	E10	С	21/05/19	
	11.	Block Diagrams – Main Switch Board Single Line Dia	gram	E11	С	21/05/19
	12.	Block Diagrams – Distribution Boards Single Line Dia	E12	С	21/05/19	
	13.	Block Diagrams – Gas & Hot Water System Schemat	ic	E13	С	21/05/19
	14.	Block Diagrams – MATV & PAYTV Schematic		E14	С	21/05/19
	15.	Block Diagrams – Video Intercom & Access Control S	E15	С	21/05/19	
	16.	Block Diagrams – NBN Schematic	E16	С	21/05/19	
	17.	Block Diagrams – NBN Notes	E17	С	21/05/19	
	18.	Basement 02 NBN Pathway Design	E18	В	21/05/19	
	19.	Basement 01 NBN Pathway Design	E19	В	21/05/19	
	20.	Ground Floor NBN Pathway Design	E20	В	21/05/19	
	21.	Typical Level 01 to 03 NBN Pathway Design	E21	В	21/05/19	
	22.	Level 04 NBN Pathway Design		E22	В	21/05/19
	23.	Roof Level NBN Pathway Design		E23	В	21/05/19
8.	Des	ign Certificate – Mechanical Services	RMJ Engine	ering P/L		23/05/19
9.	Med	chanical Services Plans	RMJ Engine	ering P/L		
		Title		Drawing No.	Revision	Date
	1.	1. Legend, General Notes, Scope of Work and Drawing List		M01	С	07/05/19
	2.	Equipment Schedule and Details	M02	С	07/05/19	
	З.	Basement 2	МОЗ	С	07/05/19	
	4.			M04	С	07/05/19
	5.			M05	С	07/05/19
	6.	Level 1-3		M06	С	07/05/19
	7.			M07	С	07/05/19
	8.	Roof	M08	С	07/05/19	



No.		Title		Prepared by	Date	
10.	Des	ign Certificate – Plumbing and Fire Services	Scott Collis	Consulting P/L	14/05/19	
11.	Hya	Iraulic & Fire Services Plans (Job No.18172)	Scott Collis	cott Collis Consulting P/L		
		Title		Drawing No.	Revision	Date
	1.	Legend, General Notes, Scope of Work and Drawing	H01	А	09/05/19	
	2.				А	09/05/19
	З.	Drainage Services Basement Level 2 Plan		Н03	А	09/05/19
	4.	Drainage Services Basement Level 1 Plan		H04	А	09/05/19
	5.	Drainage Services Level 1 Floor Plan		H06	А	09/05/19
	6.	Drainage Services Level 2 Floor Plan		H07	А	09/05/19
	7.	Drainage Services Level 3 Floor Plan		H08	А	09/05/19
	8.	Drainage Services Level 4 Floor Plan		H09	А	09/05/19
	9.	Drainage Services Roof Plan		H10	А	09/05/19
	10.	Water, Fire & Gas Services Basement Level 2 Plan	H11	В	10/05/19	
	11.	Water, Fire & Gas Services Basement Level 1 Plan	H12	В	10/05/19	
1	12.	Water, Fire & Gas Services Ground Floor Plan	H13	В	10/05/19	
	13.	Water, Fire & Gas Services Level 1 Floor Plan	H14	В	10/05/19	
	14.	Water, Fire & Gas Services Level 2 Floor Plan	H15	В	10/05/19	
	15.	Water, Fire & Gas Services Level 3 Floor Plan		H16	В	10/05/19
	16.	Water, Fire & Gas Services Level 4 Floor Plan		H17	В	10/05/19
	17.	Water, Fire & Gas Services Roof Plan		H18	А	10/05/19
12.	Des	ign Certification Ref.SS18-3760 – Landscaping	Site Image N	NSW P/L	10/05/19	
13.	Lan	dscaping Plans (Job No.SS18-3760)	Site Image N	NSW P/L		
		Title		Drawing No.	Revision	Date
	1.	Cover Sheet		000	Е	02/05/19
	2.	Existing Tree Plan		001	А	02/05/19
	З.	Landscape Plan		101	Е	02/05/19
	4.	Landscape Details		501	С	02/05/19
	5.	Landscape Details		502	А	02/05/19
14.	Lan	dscape Specification SS18-3760, Revision A	Site Image N	NSW P/L		02/05/19
15.	Stru			nt Consulting Eng	gineers	29/05/19
16.		essment Report No.FCO-3060, Revision B – Likely -combustibility performance of Hebel AAC	CSIRO – Inf	rastructure Tech	nologies	10/06/14
17.		tificate of Conformity No.CM40049 – Hebel verPanel XL Wall System	CodeMark A	lustralia		01/05/19
18.		nd & Rail Noise Impact Assessment Report 180579R1, Revision 0	Rodney Stev	vens Acoustics F	9/L	21/06/19



SCHEDULE 3 - FIRE SAFETY SCHEDULE

PROPERTY: Residential Flat Building

ADDRESS: 11-15 Mitchell Avenue, Jannali NSW 2226

PERFORMANCE BASED ALTERNATIVE SOLUTION: YES 🗌 NO 🛛

RELEVANT BCA VOLUME: BCA 2016 Amendment 1

ESSENTIAL SERVICE To be inspected or	INSTALLATION STANDARDS/LEVEL OF	NATURE OF INSPECTION OR TEST &	Existing	Proposed
TO BE INSPECTED OR STANDARDS/LEVEL OF		FREQUENCY (for information only)	Tick as appropriat	
General - Fire Resistance				
Fire-resisting Structures & Exits	BCA Sections C & D & Fire Engineering Report prepared by Homes Fire, ref: 138309.FER001b, Ver B, dated 09/05/19	Annual inspection		
Lightweight Construction	BCA Clause C1.8, BCA Specification C1.8	Annual inspection		⊠
Fire-rated (or non-combustible) Access Panels, Doors & Hoppers to Fire-resisting Shafts	BCA C3.13	To AS1851-2012		⊠
Fire Seals protecting openings in Fire-resisting components of the building (including Fire Collars & Fire-stopping/Mastic)	BCA Clause C3.15, BCA Specification C3.15 & C3.16, AS1530.4-2014	Annual inspection		
Fire-rated Lift Landing Doors	BCA Part Clause C3.10, AS1735.11-1986	To AS1851-2012		⊠
Fire Doors	BCA Part C3, BCA Specification C3.4 (Clause 2), AS1905.1-2015	To AS1851-2012		
Fire Shutters	BCA Clause C3.5, Specification C3.4 & Fire Engineering Report prepared by Homes Fire, ref: 138309.FER001b, Ver B, dated 09/05/19	To AS1851-2012		
Fire Dampers	BCA Clause C3.15, AS/NZS 1668.1-2015 AS1682.1-2015 AS1682.2-2015	To AS1851.1		⊠
General - Egress				
Paths of Travel	BCA Clause 186 EP&A Regulation 2000, BCA Section D	Monthly inspections to confirm exit doors are accessible, intact, operational & fitted with conforming hardware		⊠
Warning & Operational Signs	Fire & Smoke Door Signage - BCA Clause D2.23 Offences relating to Fire Stairs - Clause 183 of EP&A Regulation 2000 & Engineering Report prepared by Homes Fire, ref: 138309.FER001b, Ver B, dated 09/05/19	Annual inspection		×
General - Services & Equipment				
Portable Fire Extinguishers	BCA Clause E1.6, AS2444-2001	To AS1851-2012		⊠
Warning Systems associated with Lifts (including Signs)	BCA Part E3	Annual inspection		⊠
Mechanical Services				
Air-conditioning & Mechanical Ventilation/Air Handling Systems	BCA Clause E2.2, BCA Table E2.2a, BCA NSW Table E2.2b, AS1668.1-2015, AS1668	To AS1851-2012		



ESSENTIAL SERVICE TO BE INSPECTED OR	INSTALLATION STANDARDS/LEVEL OF	NATURE OF INSPECTION OR TEST &	Existing	Proposed	
TESTED	PERFORMANCE	FREQUENCY (for information only)	Tick as appropriate		
Electrical Services					
Automatic Fire Detectors & Alarm Systems including heat detectors	BCA Clause E2.2 (Clauses 3,4, 6), BCA Table E2.2a, BCA Specification E2.2a, AS1670.1-2015 & AS3786-2014 & Fire Engineering Report prepared by Homes Fire, ref: 138309.FER001b, Ver B, dated 09/05/19	To AS1851-2012			
Emergency Lighting	BCA E4.2, E4.4 & AS2293.1-2005	To AS 2293.2		⊠	
Exit Signs	BCA E4.5, E4.6, E4.8, AS2293.1-2005 & Engineering Report prepared by Homes Fire, ref: 138309.FER001b, Ver B, dated 09/05/19	To AS 2293.2		⊠	
Hydraulic Services					
Fire Hydrants	BCA Clause E1.3, AS2419.1-2005 & Fire Engineering Report prepared by Homes Fire, ref: 138309.FER001b, Ver B, dated 09/05/19	To AS1851-2012			
Fire Hose Reel Systems	BCA Clause E1.4 & AS2441-2005	To AS1851-2012		\boxtimes	
Fire Engineering Report					
Performance Solution 1 – FRL of Fire Rated Shutter The basement levels are to be separated into two fire compartments. Openings in fire walls are to be protected by doors that achieve an FRL of -/120/30. The proposed fire shutter will achieve an FRL of -/120/	 Fire Engineering Report prepared by Homes Fire, ref: 138309.FER001b, Ver B, dated 09/05/19 The Shutter shall abut 120/120/120 fire rated construction and be sealed/fire stopped against the spread of fire, and a blade wall (-/120/120 FRL) is to extend to the east of the southern column on Basement Level 1. Smoke detector to be provided on the ceiling within 1.5m of both sides of the fire shutter, Automatic closing of the carpark shutter is to be initiated by activation of smoke detector, any heat detector in the basement carpark and power failure. An audible warning device must be located near the shutter and a red flashing warning light of adequate intensity must be installed on each side of the doorway Hatched line marking is to be provided to the floor surface on either side of the carpark fire shutter. These markings are to extend not less than 2.8 m out from the shutter. Signage within the hatching is to state "KEEP CLEAR. NO PARKING. NO STORAGE'. The lettering is to be in capitals, no less than 100 mm in height and in a colour contrasting with the background. The requirement to prohibit storage and parking is to be included in the strata by-laws. 	To AS1851-2012			
Performance Solution 2 – Residential Travel Distance The maximum travel distance from the entry door of a residential SOU to an exit is permitted to be 6 m. The travel distance from SOU 106, 206 and 306 is 6.25 m measured door leaf to door leaf.	 Fire Engineering Report prepared by Homes Fire, ref: 138309.FER001b, Ver B, dated 09/05/19 The public corridors will be provided with internally illuminated exit and direction signs in accordance with BCA Part E4 and AS 2293.1-2005. The Concession within BCA Clause E4.7 is not to be applied. Security screen doors are not to be permitted to any of the SOU entry doors. 	To AS1851-2012		×	



ESSENTIAL SERVICE TO BE INSPECTED OR	INSTALLATION STANDARDS/LEVEL OF	NATURE OF INSPECTION OR TEST &	Existing	Proposed	
TESTED	PERFORMANCE	FREQUENCY (for information only)	Tick as appropriate		
Performance Solution 3 – Travel Distance in Basement Carpark The maximum travel distance in the basement carpark is permitted to be 20 m to a point of choice of exits and 40 m to an exit where two or more exits are available. The travel distance from the northwest corner of Basement Levels 1 and 2 is up to 30 m to a point of choice and 39 m to the nearest exit.	 Fire Engineering Report prepared by Homes Fire, ref: 138309.FER001b, Ver B, dated 09/05/19 Heat detection to be provided to the requirements of AS 1670.1-2015 to activate the carpark ventilation system (as per Clause 5 of AS/NZS 1668.1- 2015) The stairs serving the basement are to be fire separated from the carpark on both levels with bounding construction achieving an FRL of not less than - /120/120. Doors into the stair are to be self-closing fire rated doorsets achieving an FRL of not less than - /120/30. 	To AS1851-2012			
PerformanceSolution4Discharge ofResidentialFire-Isolated StairFire-isolated stairs are required to discharge to a road, open space, or a covered area with a ceiling height of at least 3 m and open for 1/3 of the perimeter.Fire-isolated stair FS3 discharges into a covered area that is open for 36 % of the perimeter with a ceiling height of 2.4 m and a distance of 1.2 m to open space.	Fire Engineering Report prepared by Homes Fire, ref: 138309.FER001b, Ver B, dated 09/05/19	To AS1851-2012			
Performance Solution 5 – Fire Hydrant Booster Location The building is required to be provided with a fire hydrant system in accordance with AS 2419.1- 2005, which includes a fire brigade booster connection. A remote booster is required to be located at least 10 m from the building. The proposed booster will be located in the southeast corner of the property, 9 m from the building.	 Fire Engineering Report prepared by Homes Fire, ref: 138309.FER001b, Ver B, dated 09/05/19 The walls to Unit G04 and 104 are to achieve an FRL of at least -/90/90 in both directions and the balustrade to Unit 104 is to be concrete for a height of at least 760mm. 	To AS1851-2012			
Performance Solution 6 – Hydrant System Design The building is required to be provided with a hydrant system in accordance with AS 2419.1-2005. Due to the size of the carpark, the system is required to be designed based on two hydrants flowing, requiring a flow inquiry, a flow rate of 12 L/s can only be achieved. It is proposed to design the system based on a single hydrant flowing such that the provision of on-site water storage and pumps is not required.	 Fire Engineering Report prepared by Homes Fire, ref: 138309.FER001b, Ver B, dated 09/05/19 The hydrant system is to comply with AS 2419.1-2005 other than it may be designed based on one hydrant flowing. Signage is to be provided at the booster and within the hydrant block plan provided near the FIP advising of the design pressures and flows of the system 	To AS1851-2012			



NOTICE TO APPLICANT OF MANDATORY CRITICAL STAGE INSPECTIONS

Made under Section 81A(2)(b1)(ii) of the Environmental Planning and Assessment Act 1979

APPLICAN	T DETAILS				
APPLICANT	Truland Developme	ent P/L			
ADDRESS	Suite 209, 405 Sus	sex Street, Sydney	/ NSW 2000		
TELEPHONE		MOBILE 041	7 113 188 е	MAIL kyrad@	cpdm.com.au
RELEVAN	T CONSENTS				
DEVELOPMEN	NT APPLICATION	DA18/0393	DA	TE ISSUED	20/11/2018
CONSENT AU	THORITY Suthe	erland Shire Counc	cil		
PROPOSA	L				
ADDRESS	11-15 Mitchell A	venue, Jannali N	ISW 2226		
LOT NO. 10	00	DP N	10	1250463	
BUILDING CL	ASSIFICATION	2, 7a, 7b			
SCOPE OF W	о R K S Construc	tion of a five storey	y, 31 unit reside	ntial flat building o	over two levels of basement car parking
CERTIFIE	R DETAILS				
CERTIFYING	AUTHORITY	Trenton Jones			
ACCREDITAT	ION DETAILS	Buildina Profess	ionals Board		

BPB0203 - A1 Unrestricted

I, Trenton Jones, of **AE&D Pty Ltd** located at Suite 3.04, 55 Miller St, Pyrmont, NSW 2009 acting as the principal certifier, hereby give notice in accordance with Section 109E (3) (d) of the Part 4 of the Environmental Planning and Assessment Regulation 2000-Reg 162A to the person having the benefit of the development consent, that the mandatory critical stage inspections identified in Schedule 1 overleaf are to be carried out in respect of the building work.

To allow a principal certifier or another certifying authority time to carry out mandatory critical stage inspections, the principal contractor for the building site, or the owner builder, must notify the principal certifier at least 48 hours before building work is commenced at the site if a mandatory critical stage inspection is required before the commencement of the work in accordance with Clause 162A of the Environmental Planning & Assessment Regulation 2000.

Failure to request a mandatory critical stage inspection will prohibit the principal certifier under Section 6.5 of the Environmental Planning and Assessment Act 1979 to issue an occupation certificate.

Dated: 25 June 2019

Trenton Jones Director



SCHEDULE 1: MANDATORY CRITICAL STAGE INSPECTIONS

No.	Critical Stage Inspection	Inspector
1.	First Footings After the commencement of the excavation for, and before the placement of, the first footing.	Certifying Authority
	Service Penetrations	
2.	Prior to covering of fire protection at service penetrations to building elements that are required to resist internal fire or smoke spread, inspection of a minimum of one of each type of protection method for each type of service, on each storey of the building comprising the building work.	Principal Certifier
	Bounding Wall Construction	
3.	Prior to covering the junction of any internal fire-resisting construction bounding a sole- occupancy unit (SOU), and any other building element required to resist internal fire spread, inspection of a minimum of 30% of SOUs on each storey of the building containing SOUs	Principal Certifier
	Waterproofing	
4.	Prior to covering of waterproofing in any wet areas, for a minimum of 10% of rooms with wet areas within a building. At least one unit is to be inspected.	Certifying Authority
5.	Stormwater	
5.	Prior to covering any stormwater drainage connections	Certifying Authority
	Final	
6.	After the building work has been completed and prior to any Occupation Certificate being issued in relation to the building	Principal Certifier



Binay Kumar

From:	Megan Clark
Sent:	Friday, 10 May 2019 1:50 PM
То:	ssc@ssc.nsw.gov.au
Subject:	Notice to Commence - 11-15 Mitchell Ave, Jannali
Attachments:	19.02.19 CC1 Jannali - AED NTC Form - Signed.pdf; 8899-01-2019-CC Certificate.pdf

Attention Planning & Development Manager

In accordance with the Environmental Planning & Assessment Regulations 2000, please find attached Notice to Commence and Appointment of PCA for Development Consent DA18/0393 approved at 11-15 Mitchell Avenue, Jannali.

A copy of the Construction Certificate has been attached for your record and a complete package including stamped plans, Supporting Documents and lodgement fee has been forward to Council.

Kind Regards

Megan Clark

TEAM ADMINISTRATION / ASSISTANT BUILDING SURVEYOR AED



Head Office: Suite 3.04, 55 Miller Street, Pyrmont NSW 2009

Southern Highlands Office: Unit 10/19 Lyell Street, Mittagong NSW 2575 Sutherland Shire Office: Level 1 Regus, Suite 20, 29 Kiora Road, Miranda NSW 2228 Phone: 02-9571 8433 (Ext.770) Direct: (02) 8570 1770 Email: megan@aedconsulting.com.au VCard: Megan Clark.vcf

www.aedconsulting.com.au | AED Capability Statement | AED Access Capability Statement | AED Fire Capability Statement

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DA 000 DA 001	COVER SHEET & BASIX COMMITMENT PROJECT SUMMARY
DA 100 DA 101 DA 102 DA 103 DA 104 DA 105 DA 106	BASEMENT 1 PLAN GROUND FLOOR PLAN LEVEL 1-3 PLAN LEVEL 4 PLAN
DA 201 DA 202 DA 203 DA 204	
DA 301 DA 302 DA 401 DA 402	
	PERSPECTIVE VIEW PERSPECTIVE VIEW PERSPECTIVE VIEW
DA 500 DA 510 DA 551 DA 552 DA 580	FSR PLAN DEEP SOIL & COMMUNAL OPEN SPACE STORAGE DIAGRAM STORAGE DIAGRAM 16m HEIGHT PLANE DIAGRAM
DA801 DA802 DA803	ADAPTABLE LAYOUT - TYPE A ADAPTABLE LAYOUT - TYPE B ADAPTABLE LAYOUT - TYPE C

AREA SCHEDULE

AREA SCHE	Unit No.	Туре	Unit Area (m2)	Terrace/ Balcony (m2)	Unit Storage (m3)	Basement Storage (m3)	Total Storage (m3)	Adaptable Unit	Livable Unit
GF	G01	1 bed	56	20	3	3	6	\checkmark	
	G02	2 bed	85	50	4	4	8		
	G03	2 bed	76	74	4	4	8		
	G04	2 bed	84	97	4	4	8		
	G05	2 bed	77	135	4	4	8		
	G06	3 bed	99	89	5	5	10		
	G07	1 bed	51	26	3	3	6	\checkmark	
_evel 1	101	2 bed	76	18	4	4	8		
	102	2 bed	85	12	4	4	8		
	103	2 bed	76	13	4	4	8		
	104	2 bed	84	21	4	4	8		
	105	2 bed	77	29	4	4	8		\checkmark
	106	3 bed	99	18	5	5	10		
	107	1 bed	51	13	3	3	6	\checkmark	
Level 2	201	2 bed	76	18	4	4	8		
	202	2 bed	85	12	4	4	8		
	203	2 bed	76	13	4	4	8		
	204	2 bed	84	21	4	4	8		
	205	2 bed	77	29	4	4	8		\checkmark
	206	3 bed	99	18	5	5	10		
	207	1 bed	51	13	3	3	6	\checkmark	
_evel 3	301	2 bed	76	18	4	4	8		
	302	2 bed	85	12	4	4	8		
	303	2 bed	76	13	4	4	8		
	304	2 bed	84	21	4	4	8		
	305	2 bed	77	29	4	4	8		\checkmark
	306	3 bed	99	18	5	5	10		
	307	1 bed	51	13	3	3	6	\checkmark	
_evel 4	401	2 bed	81	53	4	4	8		
	402	2 bed	84	23	4	4	8		
	403	3 bed	98	87	5	5	10	√	

Project:	Address:	11-15 Mitchell Aver	nue, Jannali NSW			
	Applicant:	Truland Developme	ent Pty Ltd			
Contact:	Name:	Layla Kim - PBD				
	Contact:	layla@pbdarchite	ects.com.au			
Assessor:	Name:	Victor Lin			Company:	Victor Lin & Associates
	Address:	PO Box 5080. Sth Tu	urramurra. 2074		Number:	BDAV/12/1454
	Contact:	0412-988088			Email:	vlin007@hotmail.com
Ext. Walls:	Construction		Insulation		Colour	Details
	Hebel wall		None		Med	As per plans
			R1.5			See table below
	Weatherboard	Cavity	None			As per plans
Int. Walls:	Construction					Details
	Hebel wall		None			As per plans
Floors:	Construction		Insulation			Details
	Concrete		None			Carpet, Tiles, Timber
			R2.0			Floor above car park
			R3.0			See table below
Ceilings:	Construction		Insulation			Details
	Suspended Plas	terboard	R4.0			Under all roofs & Ceiling with balcony above
Roof:	Construction		Insulation		Colour	Details
	Concrete		None		Medium	As per plans
Windows:	Product ID		Glass	Frame	Uw/SHGCw	Window types
	Generic		Single Clear	Aluminium	6.70 / 0.70	Fixed & sliding windows and doors
					6.70 / 0.57	Awning windows
			Sinlge Low E		5.40 / 0.58	Sliding windows/doors
Skylights:	Product ID		Glass	Frame	Uw/SHGCw	Details
	Generic		Single Clear	Aluminium/timber	NA	
Other:	Orientation		Terrain	Weatherseals	Climate Zone	Recessed Downlights
	15		Suburban	Yes	56	YES - SEALED TYPE ONL

Assessor Construction Summary

Other Project Buildings **Overshadowing Details:** nent: Drawings: dwgs as stamped File Ref: 4177A BERS Pro 4.3 Software:

Certification	Number:	0003200790			Date:	23-Septe	mber-201	8
			lso to table above)					
Unit No.	Floor Insulation R2.0	Wall Insulation R1.5	Ceiling Insulation R4.0	Roof Insulation	Low E	Additional Requirements	SEALED Recessed Downlight s ONLY	Sealed exhaust vents
G001	Х	Х					Х	Х
G002	х						х	х
G003	х						Х	Х
G004	x	Х					х	х
G005	R3.0	х					х	Х
G006	х						х	х
G007	х							
101							х	Х
102							Х	Х
103							Х	Х
104		Х					Х	Х
105		Х			South facing windows in living/dining		х	х
106							х	х
107								
201							х	Х
202							х	х

Unit No.	Floor Insulation R2.0	Wall Insulation R1.5	Ceiling Insulation R4.0	on Summary (refer al	Low E	Additional Requirements	SEALED Recessed Downlight s ONLY	Sealed exhaust vents
203							Х	Х
204		х					х	х
205		х			South facing windows in living/dining		х	х
206							х	х
207							х	Х
301			Х				х	х
302			Х				х	х
303							х	Х
304		Х					х	Х
305		х	Х		South facing windows in living/dining		х	х
306							Х	Х
307							Х	Х
401			Х				Х	Х
402		Х	Х				х	Х
403			Х				Х	х

Lin & Associates Pty Ltd, makes no representations or warranties in relation to the accuracy or completeness of the information found on it. In no event will Victor Lln & Associates Pty Ltd, be liable for any damages whatsoever for any differences between this summary and the NatHERS Univesal Certificates that relate to this project. You accept that it is your responsibility to check the Universal Certificates and comply with any differences that may exist on those certificates.



Mitchell Ave Developments P/L vs Forte Sydney Constructions P/L Report issued: 25 February 2022

- GENERAL NOTES:
- ALL WORKS TO COMPLY WITH BUILDING CODE OF AUSTRALIA, REQUIREMENTS OF RELEVANT STATUTORY AUTHORITIES/ LOCAL GOVERNMENT & RELEVANT AUSTRALIAN
- BUILDING STANDARDS
 CONTRACTOR TO VERIFY ALL DIMENSIONS ON SITE BEFORE COMMENCING WORK- SHOULD A DISCREPANCY BE IDENTIFIED PLEASE CONFIRM WITH ARCHITECT PRIOR TO PROCEEDING (DO
- DRAWINGS FOR THE PURPOSES OF DA ONLY FURTHER CONSULTANT / AUTHORITY COORDINATION WILL BE REQUIRED AT CC STAGE WHICH MAY IMPACT ON DESIGN AND
- PLANNING LAYOUTS COPYRIGHT OF DESIGN SHOWN HEREON IS RETAINED BY PBD ARCHITECTS AND AUTHORITY IS REQUIRED FOR ANY REPRODUCTION

LEGEND:

FHR

ΜV

OP

PВ

ΡS

R

RCL

- AW AWNING BATTEN SCREEN BS
- A/C CONDENSER UNITS CU FIRE HYDRANT FH
 - FIRE HOSE REEL
- FS FIRE STAIRS GARBAGE BIN
- GARBAGE CHUTE GC HIGHLIGHT WINDOW ΗL
- ROOF HATCH ACCESS MA MB
- MAILBOX TO FUTURE DETAIL MECHANICAL RISER TO FUTURE DETAIL
- OPAQUE WINDOW PRE-FABRICATED PLANTERBOX
- SLIDING PRIVACY SCREEN
- RECYCLING BIN RETRACTABLE CLOTHES LINE
- SK SKY LIGHT STORAGE ST

Fixed & sliding windows and doors Awning windows

Details

Recessed Downlights YES - SEALED TYPE ONLY

	Additional	SEALED Recessed	Sealed
Date:	23-Septen	nber-201	8
	5.6 Average star rating NATIONWIDE HER Set two Set	Name: Victor Lin tion no.: VIC/BDAV/ e date: 24 Septemb Address: itchell Avenue	
	50mm LED at 1 per 5	sqm of ceilii	ng space

Disclaimer: By using this summary you are accepting all the terms of this disclaimer notice. While every effort is made to ensure that the content of this summary is accurate, the summary is provided "as is" and Victor

Certificate no.: Assessor Name: Accreditation no.: Certificate date: Dwelling Address: 11-15 Mitchell Avenue Jannali, NSW

2226

0003200790 Victor Lin VIC/BDAV/12/1454 24 September 2018



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Harper Building Consultants Pty Ltd

SSUE	DATE	DESCRIPTION
Ą	28.03.2018	ISSUED FOR DA
3	21.09.2018	REVISED DA

TRULAND DEVELOPMENT PTY LTD

ARCHITECT:

PROJECT:

CLIENT:



Level 2, 52 Albion Street, Surry Hills NSW 2010

PROPOSED RESIDENTIAL DEVELOPMENT 11-15 MITCHELL AVENUE, JANNALI

MARCH 2018

ISSUE:

В

DRAWING TITLE: COVER SHEET - REVISED DA & BASIX COMMITMENT



PROJECT INFORMATION		
11-15 Mitchell Avenue, Jannali		
014- 4	0120	
Site Area (m²)	2132	
Allowable FSR	1.2 : 1	
Permissible GFA (m ²)	2558	
Zoning	R4 - Residential Flat	
Height Control	16m	
_		
Height Control	16m	

UNIT MIX				
Level	Bed: 1	Bed: 2	Bed: 3	
		r	r	
GF	2	4	1	
LEVEL 1	1	5	1	
LEVEL 2	1	5	1	
LEVEL 3	1	5	1	
LEVEL 4	0	2	1	
TOTAL	5	21	5	
	16%	68%	16%	


CAR PARKING / BICYCLE REQUIREMENTS


	Rate	No. of Units	Required (min.)	
Residential				
1 Bed	1	5	5	
2 Bed	1.5	21	31.5	
3 Bed	2	5	10	
			46.5	
Car wash bay			1	
Visitor	1 per 4 units	31	7.8	
Accessible	1 per adaptable unit		6.2	
				For
TOTAL			55.3	
Bicycle	1 bicycle space per 10 carspace		5.6	

WASTE GENERATION & MANAGEMENT (120L per unit on weekly basis, uncompacted)

Type of Bin	Litres / Per Week		j.
Garbage	3720	15.5 (240L)	
Recycling	3720	15.5 (240L)	



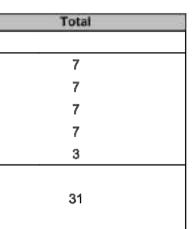

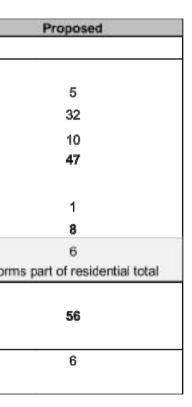

Proposed 16 (240L) BINS 16 (240L) BINS

GFA				
Area				
564				
572				
572				
572				
277				
2557				
1.2 : 1				
	564 572 572 572 277 2557			

Other Requirements

Council / ADG Req	Required	Proposed
min. 30% of Site Area	639.6	680 = 32%
min. 25% of Site Area	533	388 = 18%
min. 70% of Apartments	21.7	22 = 71%
min. 60% of Apartments	18.6	23 = 74%
20% of Apartments	6.2	6 units
10% of Apartments	3.1	3 units
	min. 30% of Site Area min. 25% of Site Area min. 70% of Apartments min. 60% of Apartments 20% of Apartments	min. 30% of Site Area639.6min. 25% of Site Area533min. 70% of Apartments21.7min. 60% of Apartments18.620% of Apartments6.2

Mitchell Ave Developments P/L vs Forte Sydney Constructions P/L Report issued: 25 February 2022

GENERAL NOTES:

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- PLANNING LAYOUTS
- COPYRIGHT OF DESIGN SHOWN HEREON IS RETAINED BY PBD ARCHITECTS AND AUTHORITY IS REQUIRED FOR ANY REPRODUCTION

LEGEND:

- AW AWNING BS BATTEN SCREEN CU A/C CONDENSER UNITS FH FIRE HYDRANT
- FHR FIRE HOSE REEL
- FS FIRE STAIRS GARBAGE BIN G
- GARBAGE CHUTE GC HIGHLIGHT WINDOW HL
- ROOF HATCH ACCESS MA MB
- MAILBOX TO FUTURE DETAIL MECHANICAL RISER TO FUTURE DETAIL ΜV
- OP OPAQUE WINDOW PRE-FABRICATED PLANTERBOX РB ΡS
 - SLIDING PRIVACY SCREEN
- R RECYCLING BIN RCL RETRACTABLE CLOTHES LINE SK SKY LIGHT ST STORAGE



Accreditation no .: Certificate date: 11-15 Mitchell Avenue

VIC/BDAV/12/1454 24 September 2018



21.09.2018 REVISED DA 28.03.2018 ISSUED FOR DA ISSUE DATE DESCRIPTION

www.nathers.gov.au

CLIENT: TRULAND DEVELOPMENT PTY LTD

ARCHITECT:



Level 2, 52 Albion Street, Surry Hills NSW 2010 PROJECT:

PROPOSED RESIDENTIAL DEVELOPMENT 11-15 MITCHELL AVENUE, JANNALI

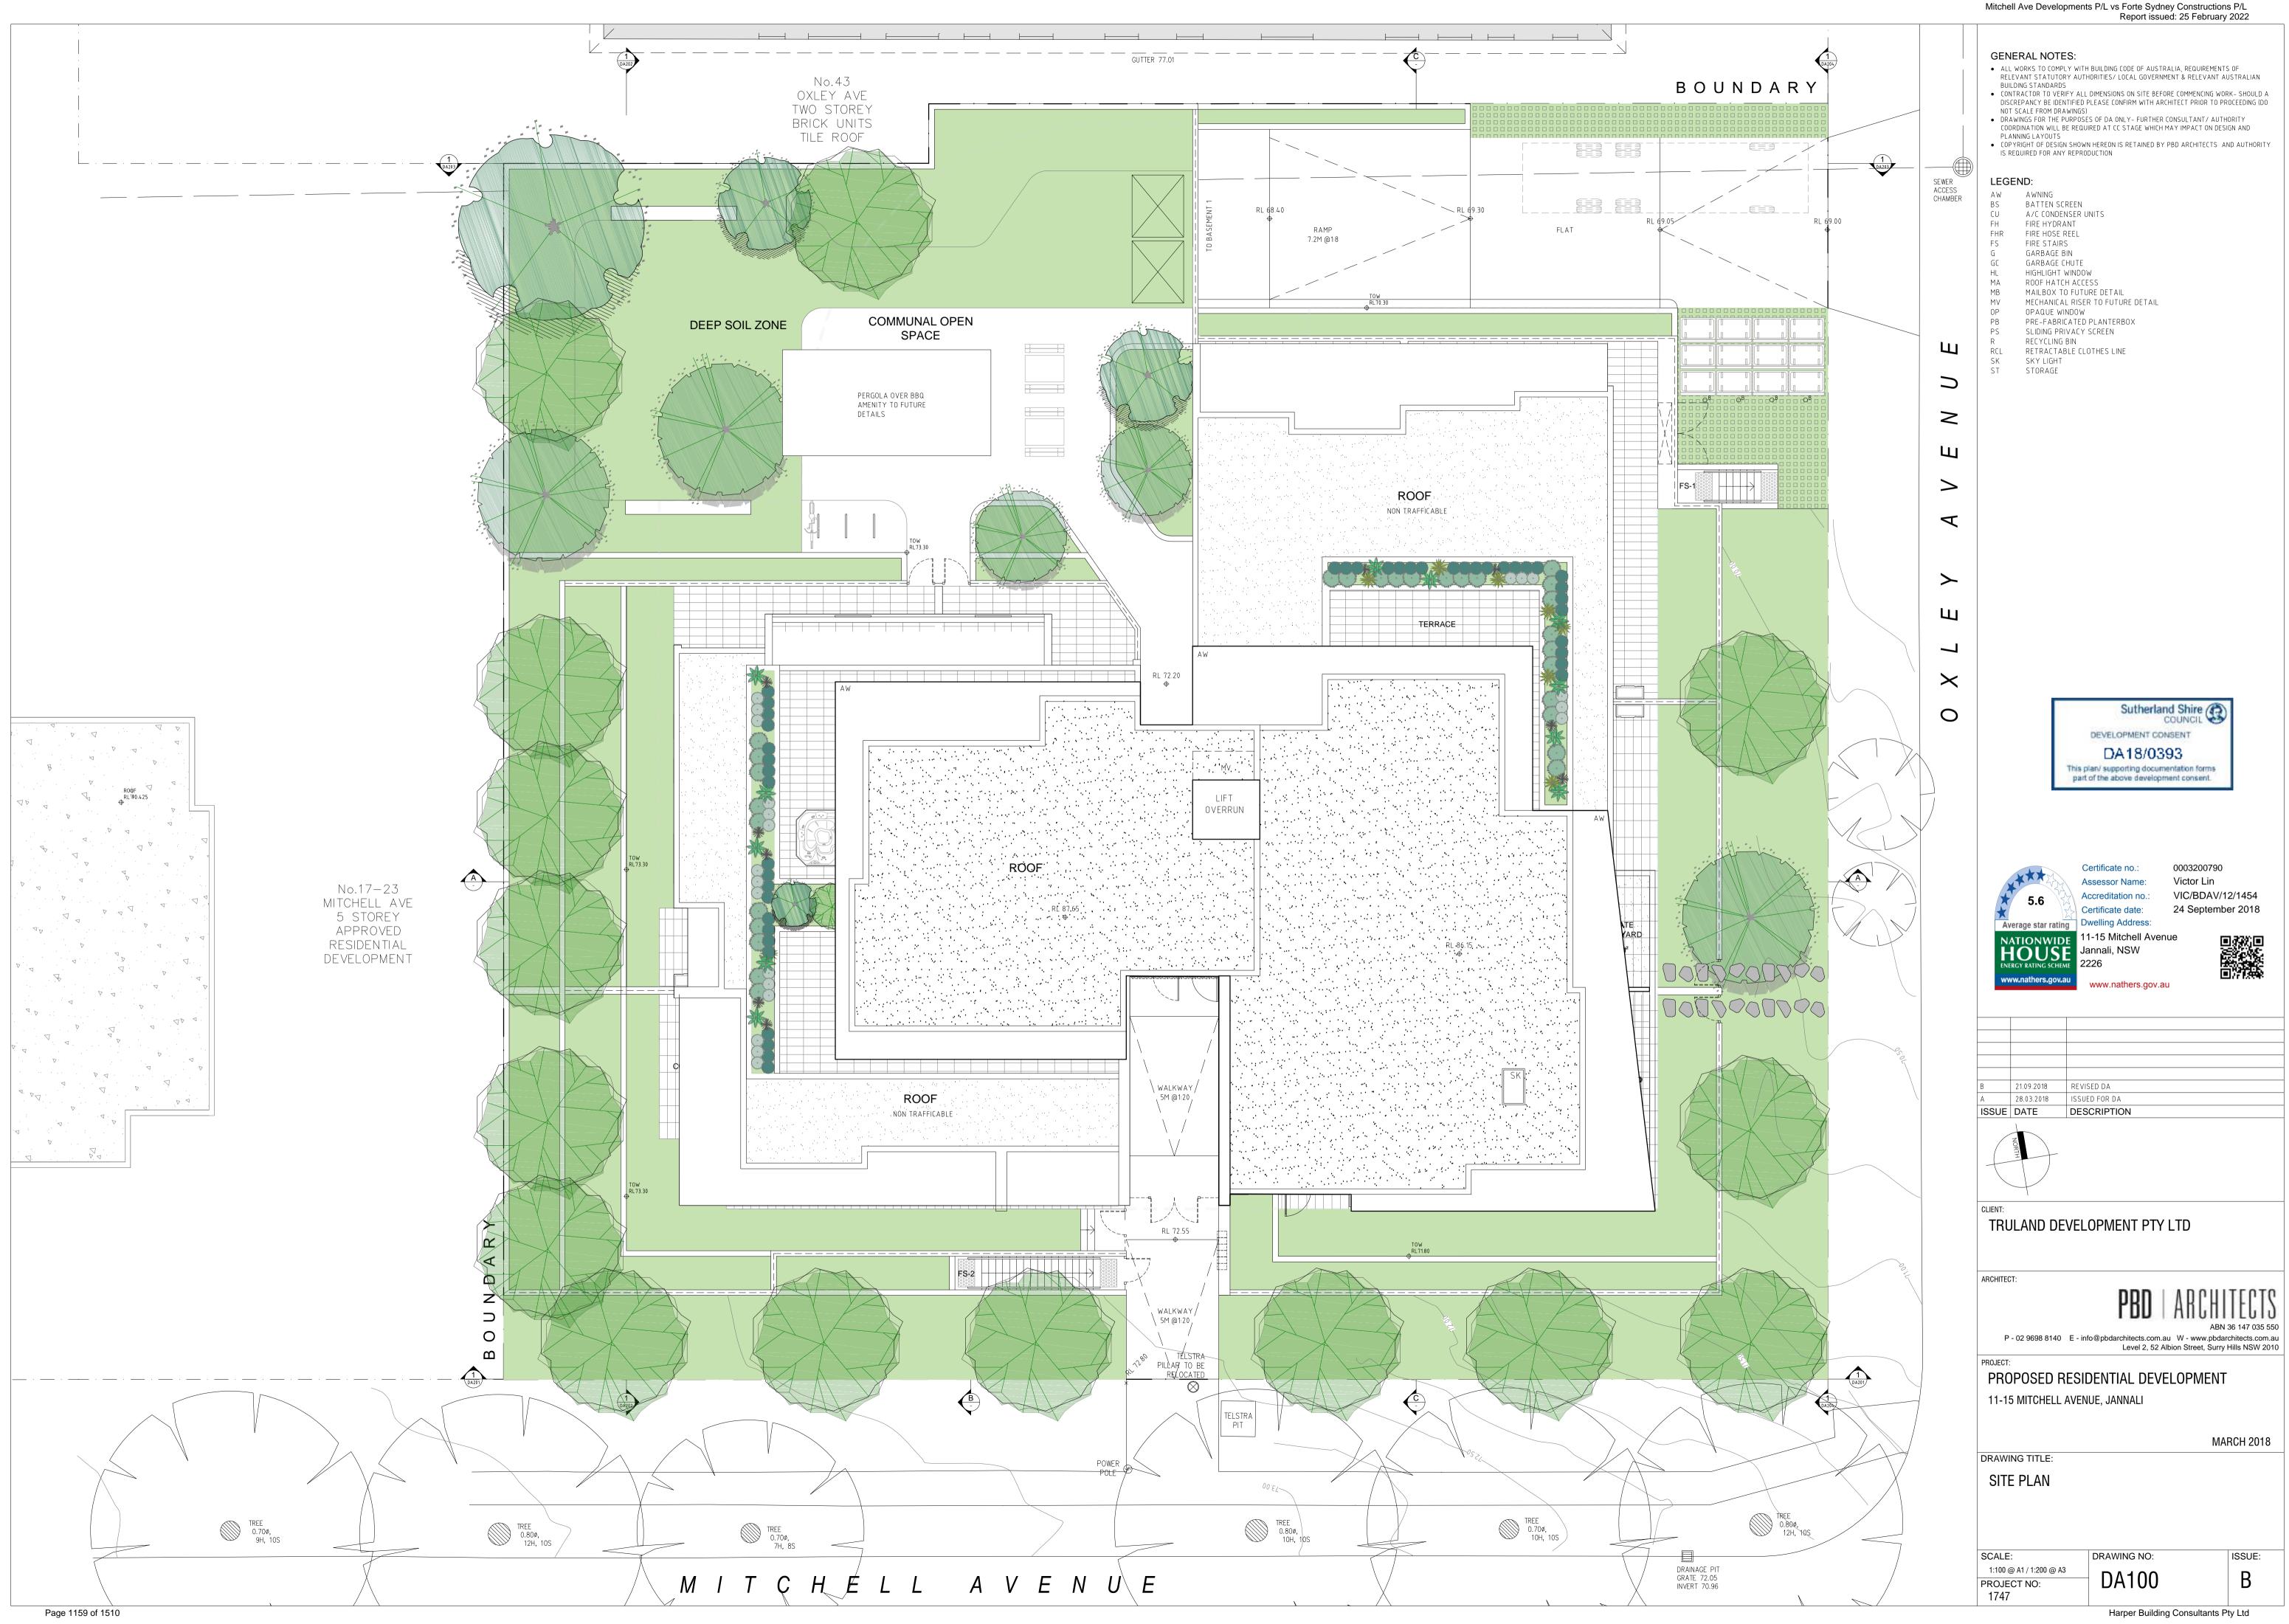
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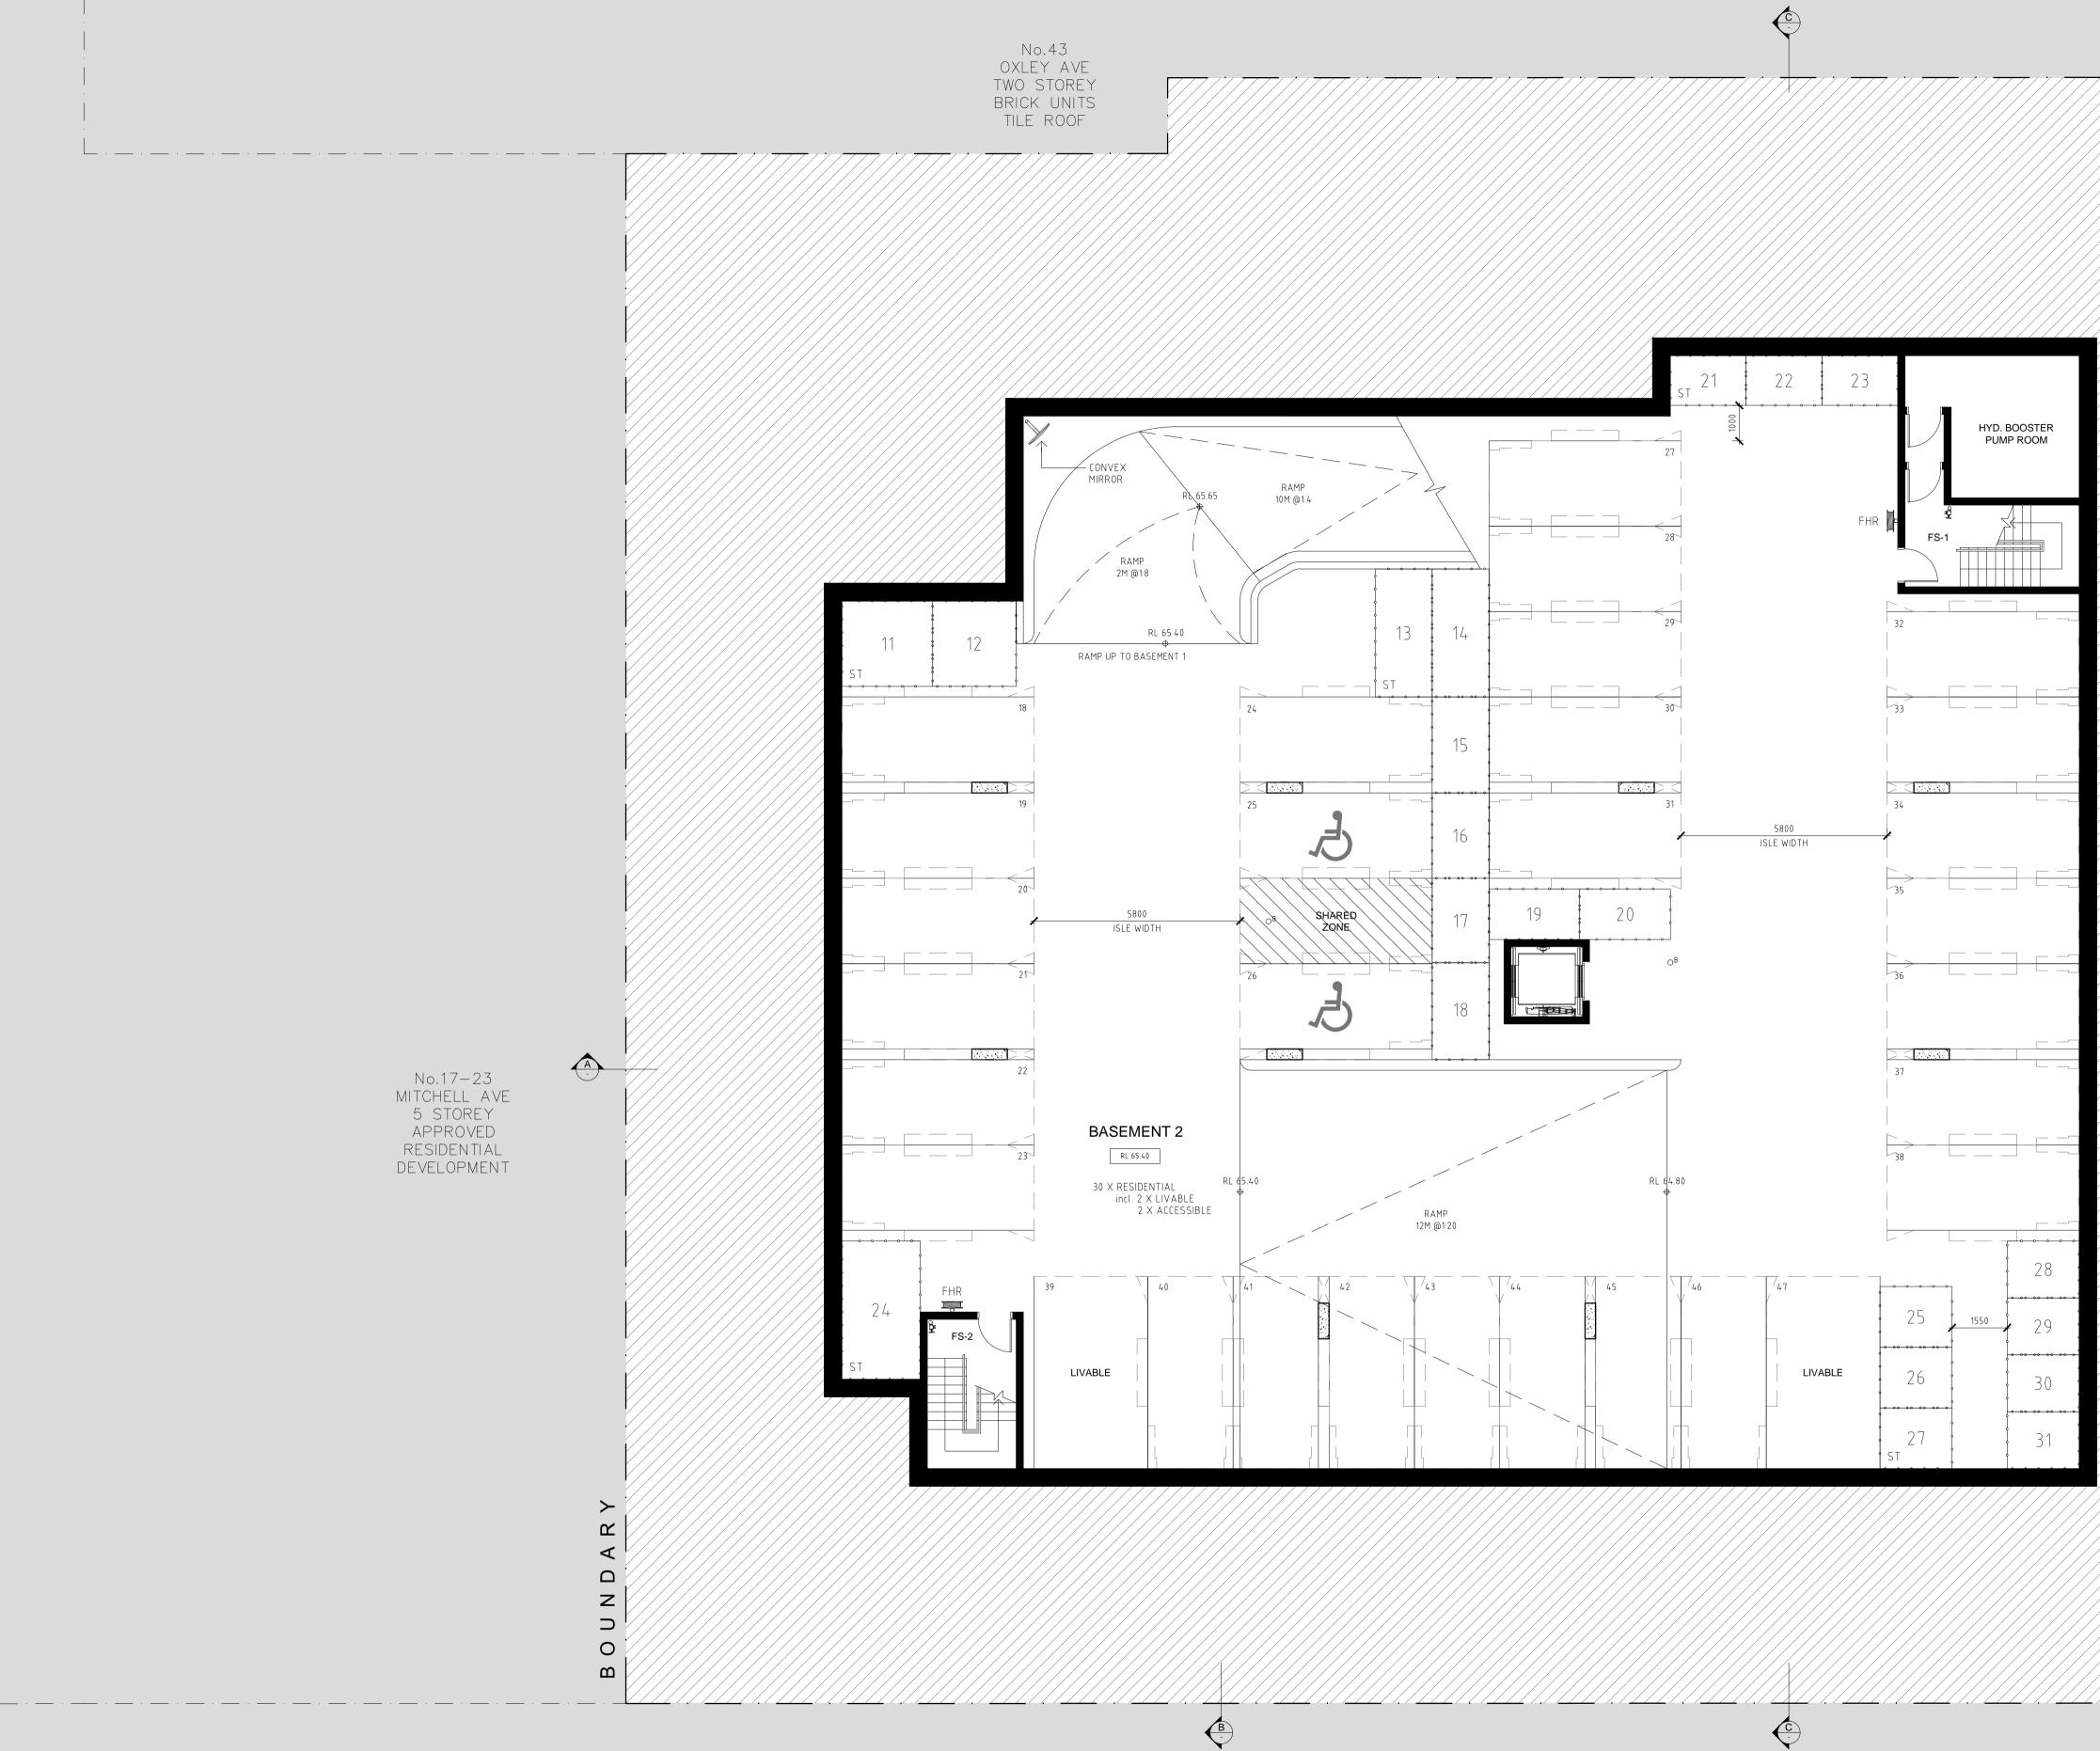
MARCH 2018

PROJECT SUMMARY

SCALE: N/A DRAWING NO: ISSUE: В DA001 PROJECT NO: 1747 Harper Building Consultants Pty Ltd

Sutherland Shire COUNCIL This plan/ supporting documentation forms part of the above development consent.

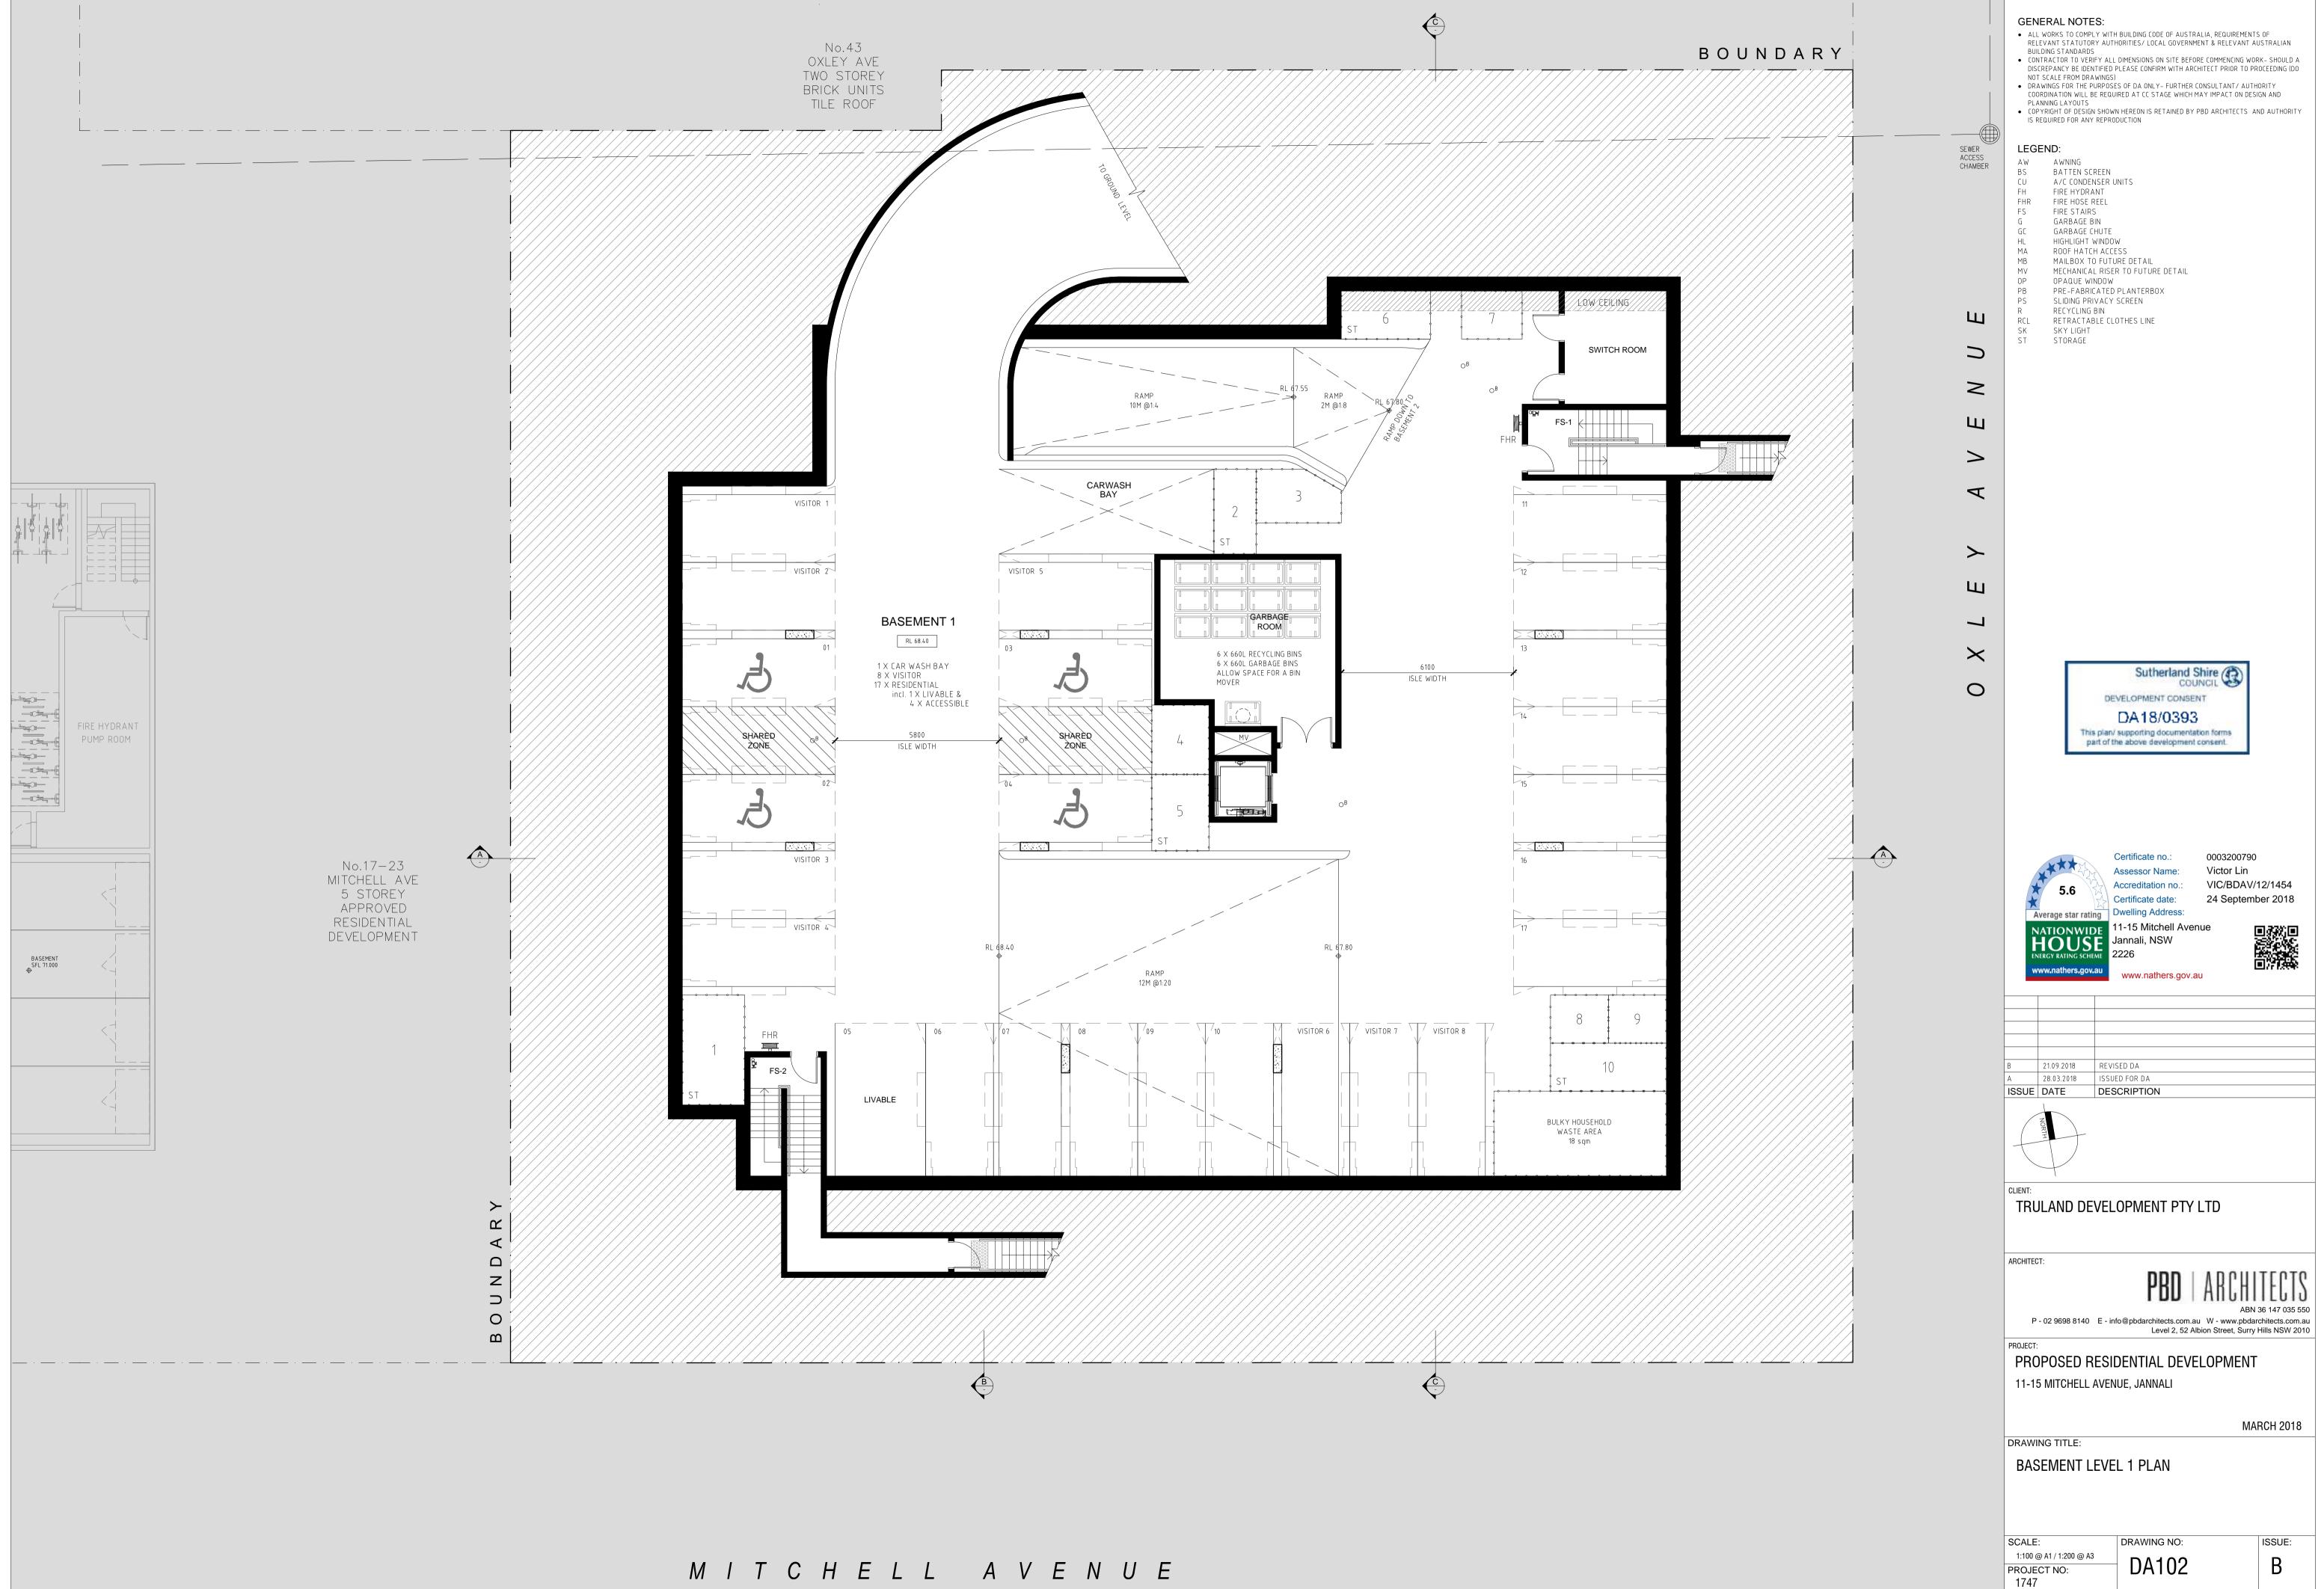




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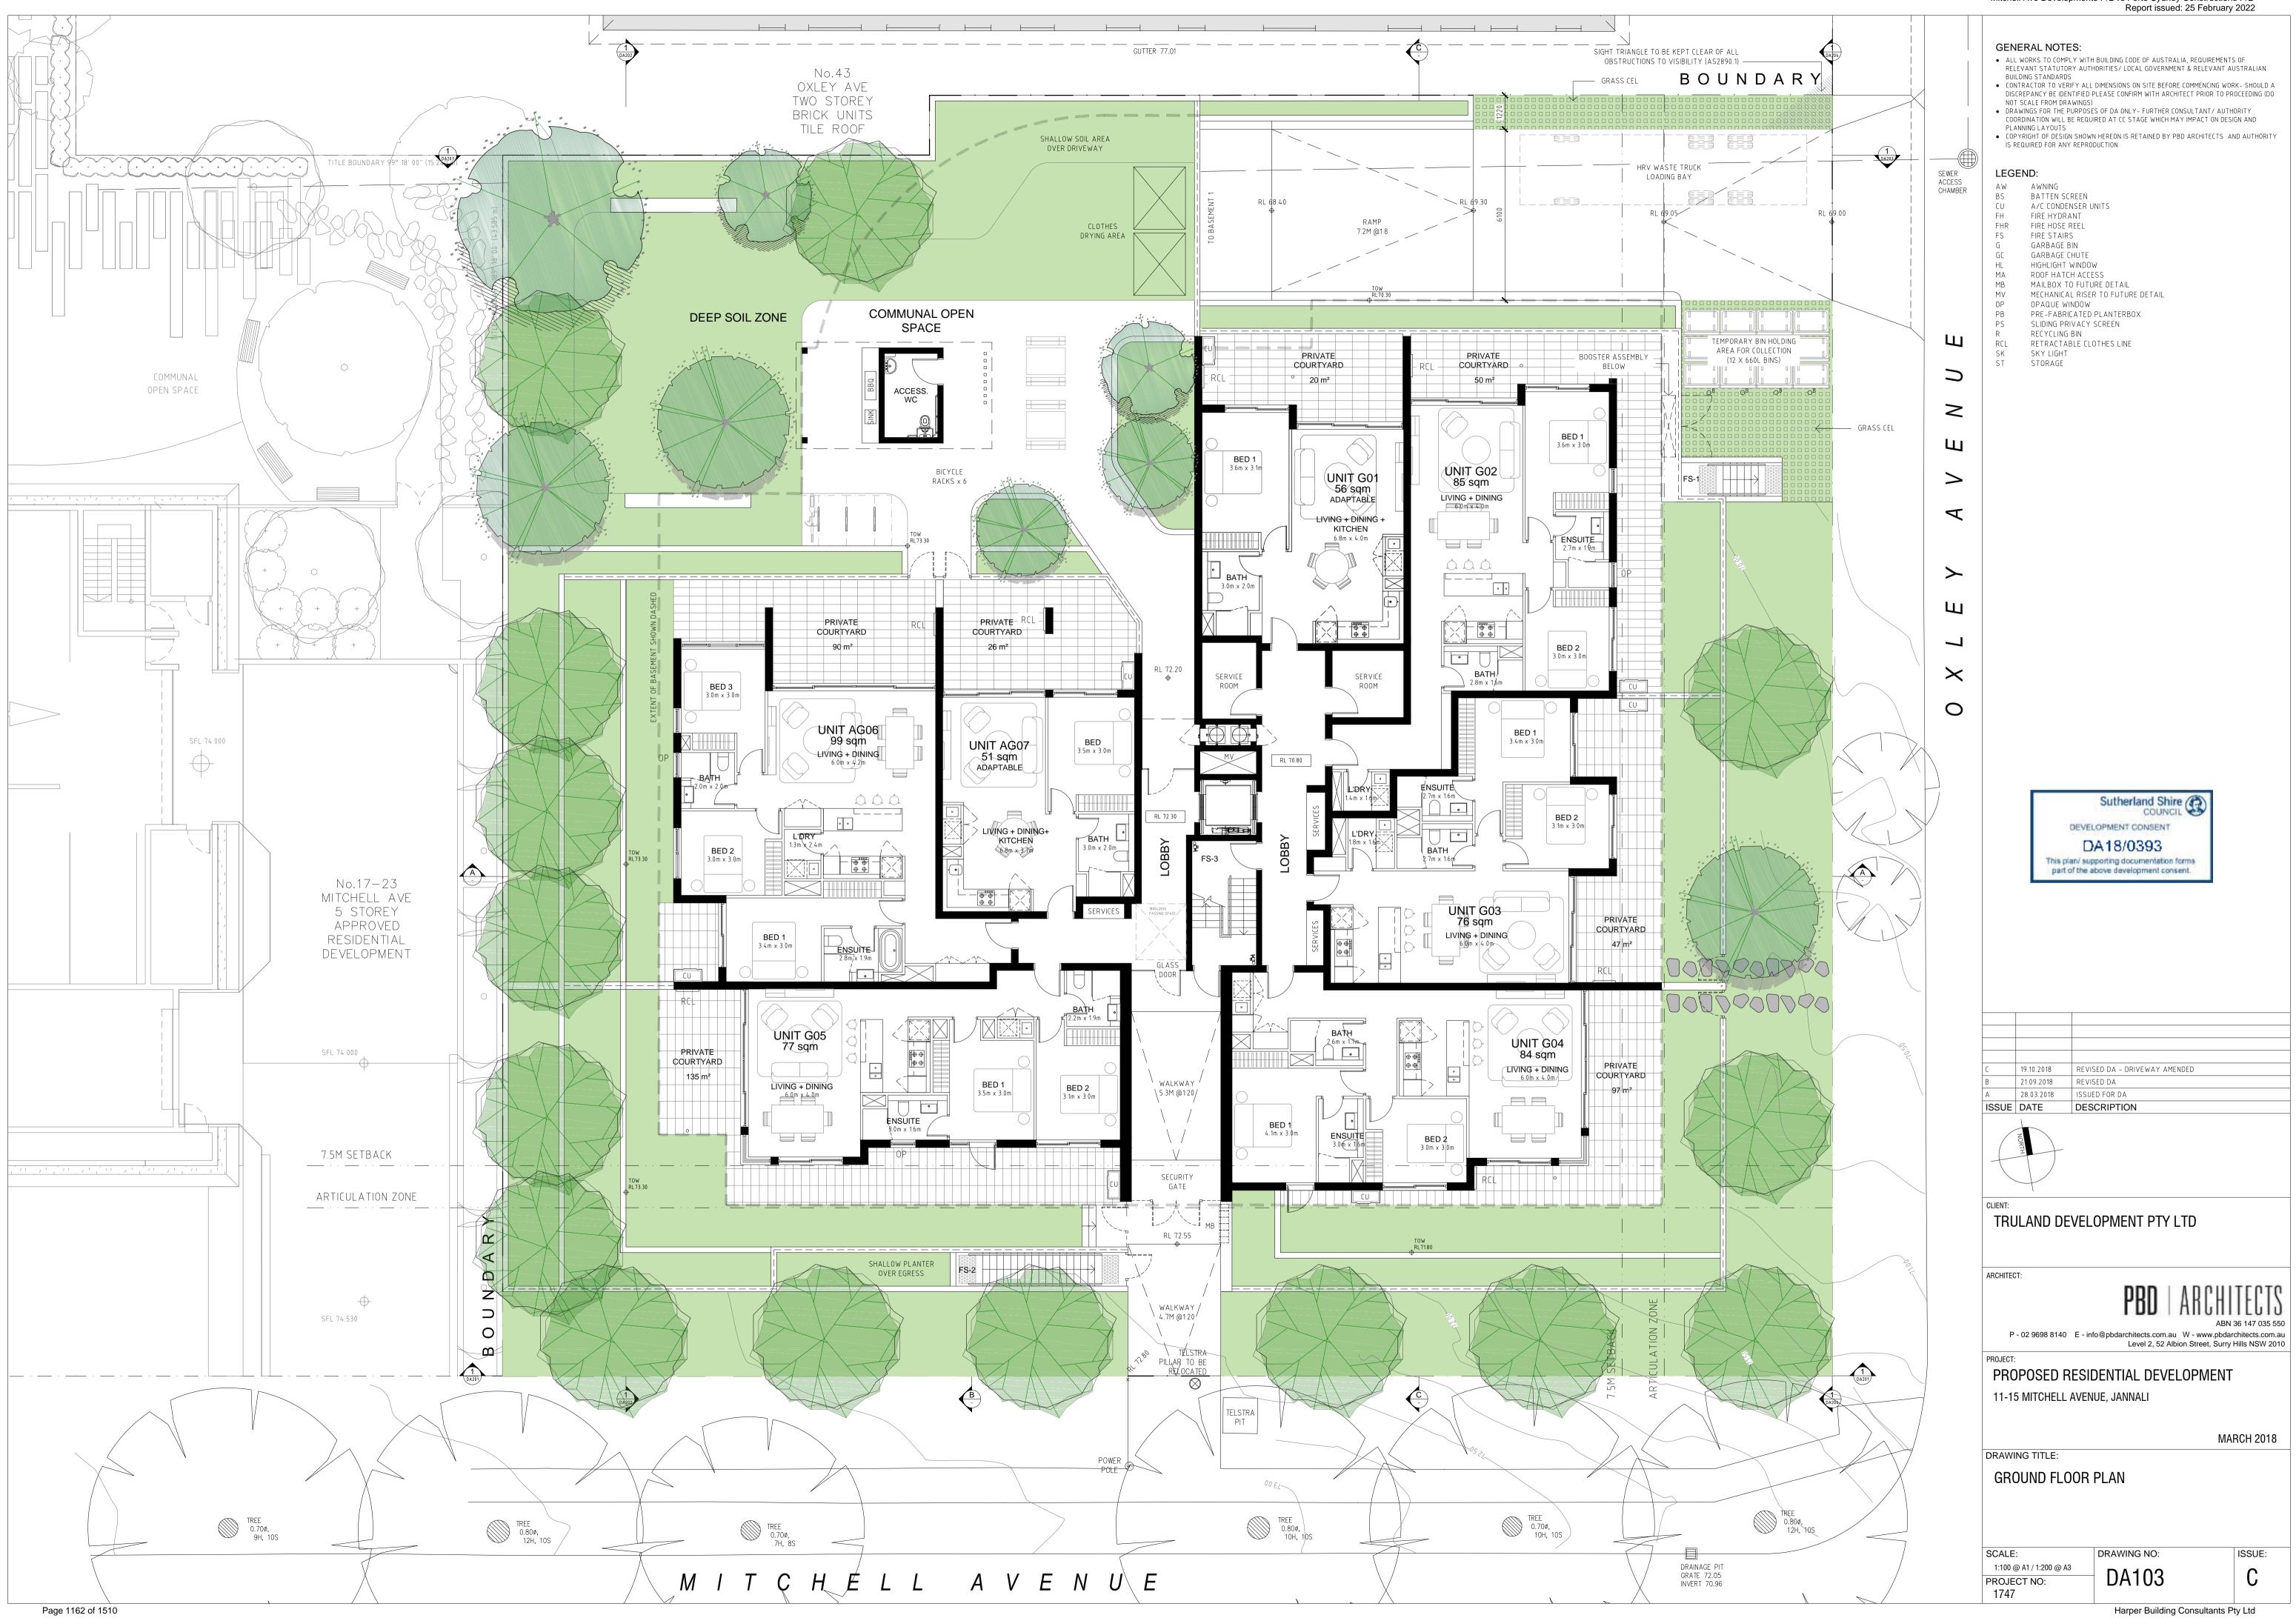
	AVENUE	RELEVANT STATUT BUILDING STANDAR CONTRACTOR TO VE DISCREPANCY BE ID NOT SCALE FROM DI DRAWINGS FOR THE COORDINATION WILL PLANNING LAYOUTS COPYRIGHT OF DESI IS REQUIRED FOR AN AW AWNING BS BATTEN S CU A/C COND FH FIRE HYDF FHR FIRE HYDF FHR FIRE HOSE FS FIRE STAI G GARBAGE GC GARBAGE GC GARBAGE HL HIGHLIGHT MA ROOF HAT MB MAILBOX MV MECHANIC OP OPAQUE N PB PRE-FABF PS SLIDING P R RECYCLIN	IPLY WITH ORY AUTH DS RIFY ALL ENTIFIED I RAWINGS} PURPOSE BE REQU GN SHOW YY REPRO SCREEN ENSER L RANT E REEL RS BIN CHUTE TO FUTL AL RISEI WINDOW RICATED RIVACY G BIN ABLE CLI T	S OF DA ONLY- FURTHER CONSULT IRED AT CC STAGE WHICH MAY IMPA N HEREON IS RETAINED BY PBD ARCH DUCTION INITS INITS IRE DETAIL R TO FUTURE DETAIL PLANTERBOX	ELEVANT A ENCING WOI RIOR TO PF ANT/ AUTH CT ON DES	USTRALIAN RK- SHOULD A ROCEEDING (DO IORITY IGN AND
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		RCHITECT:	RE VI: 1SSUI	www.nathers.gov.au		
		PROJECT:	RESII	fo@pbdarchitects.com.au W - w Level 2, 52 Albion Stre DENTIAL DEVELOP UE, JANNALI	ABN ww.pbdan eet, Surry	36 147 035 550 rchitects.com.au Hills NSW 2010

Mitchell Ave Developments P/L vs Forte Sydney Constructions P/L Report issued: 25 February 2022

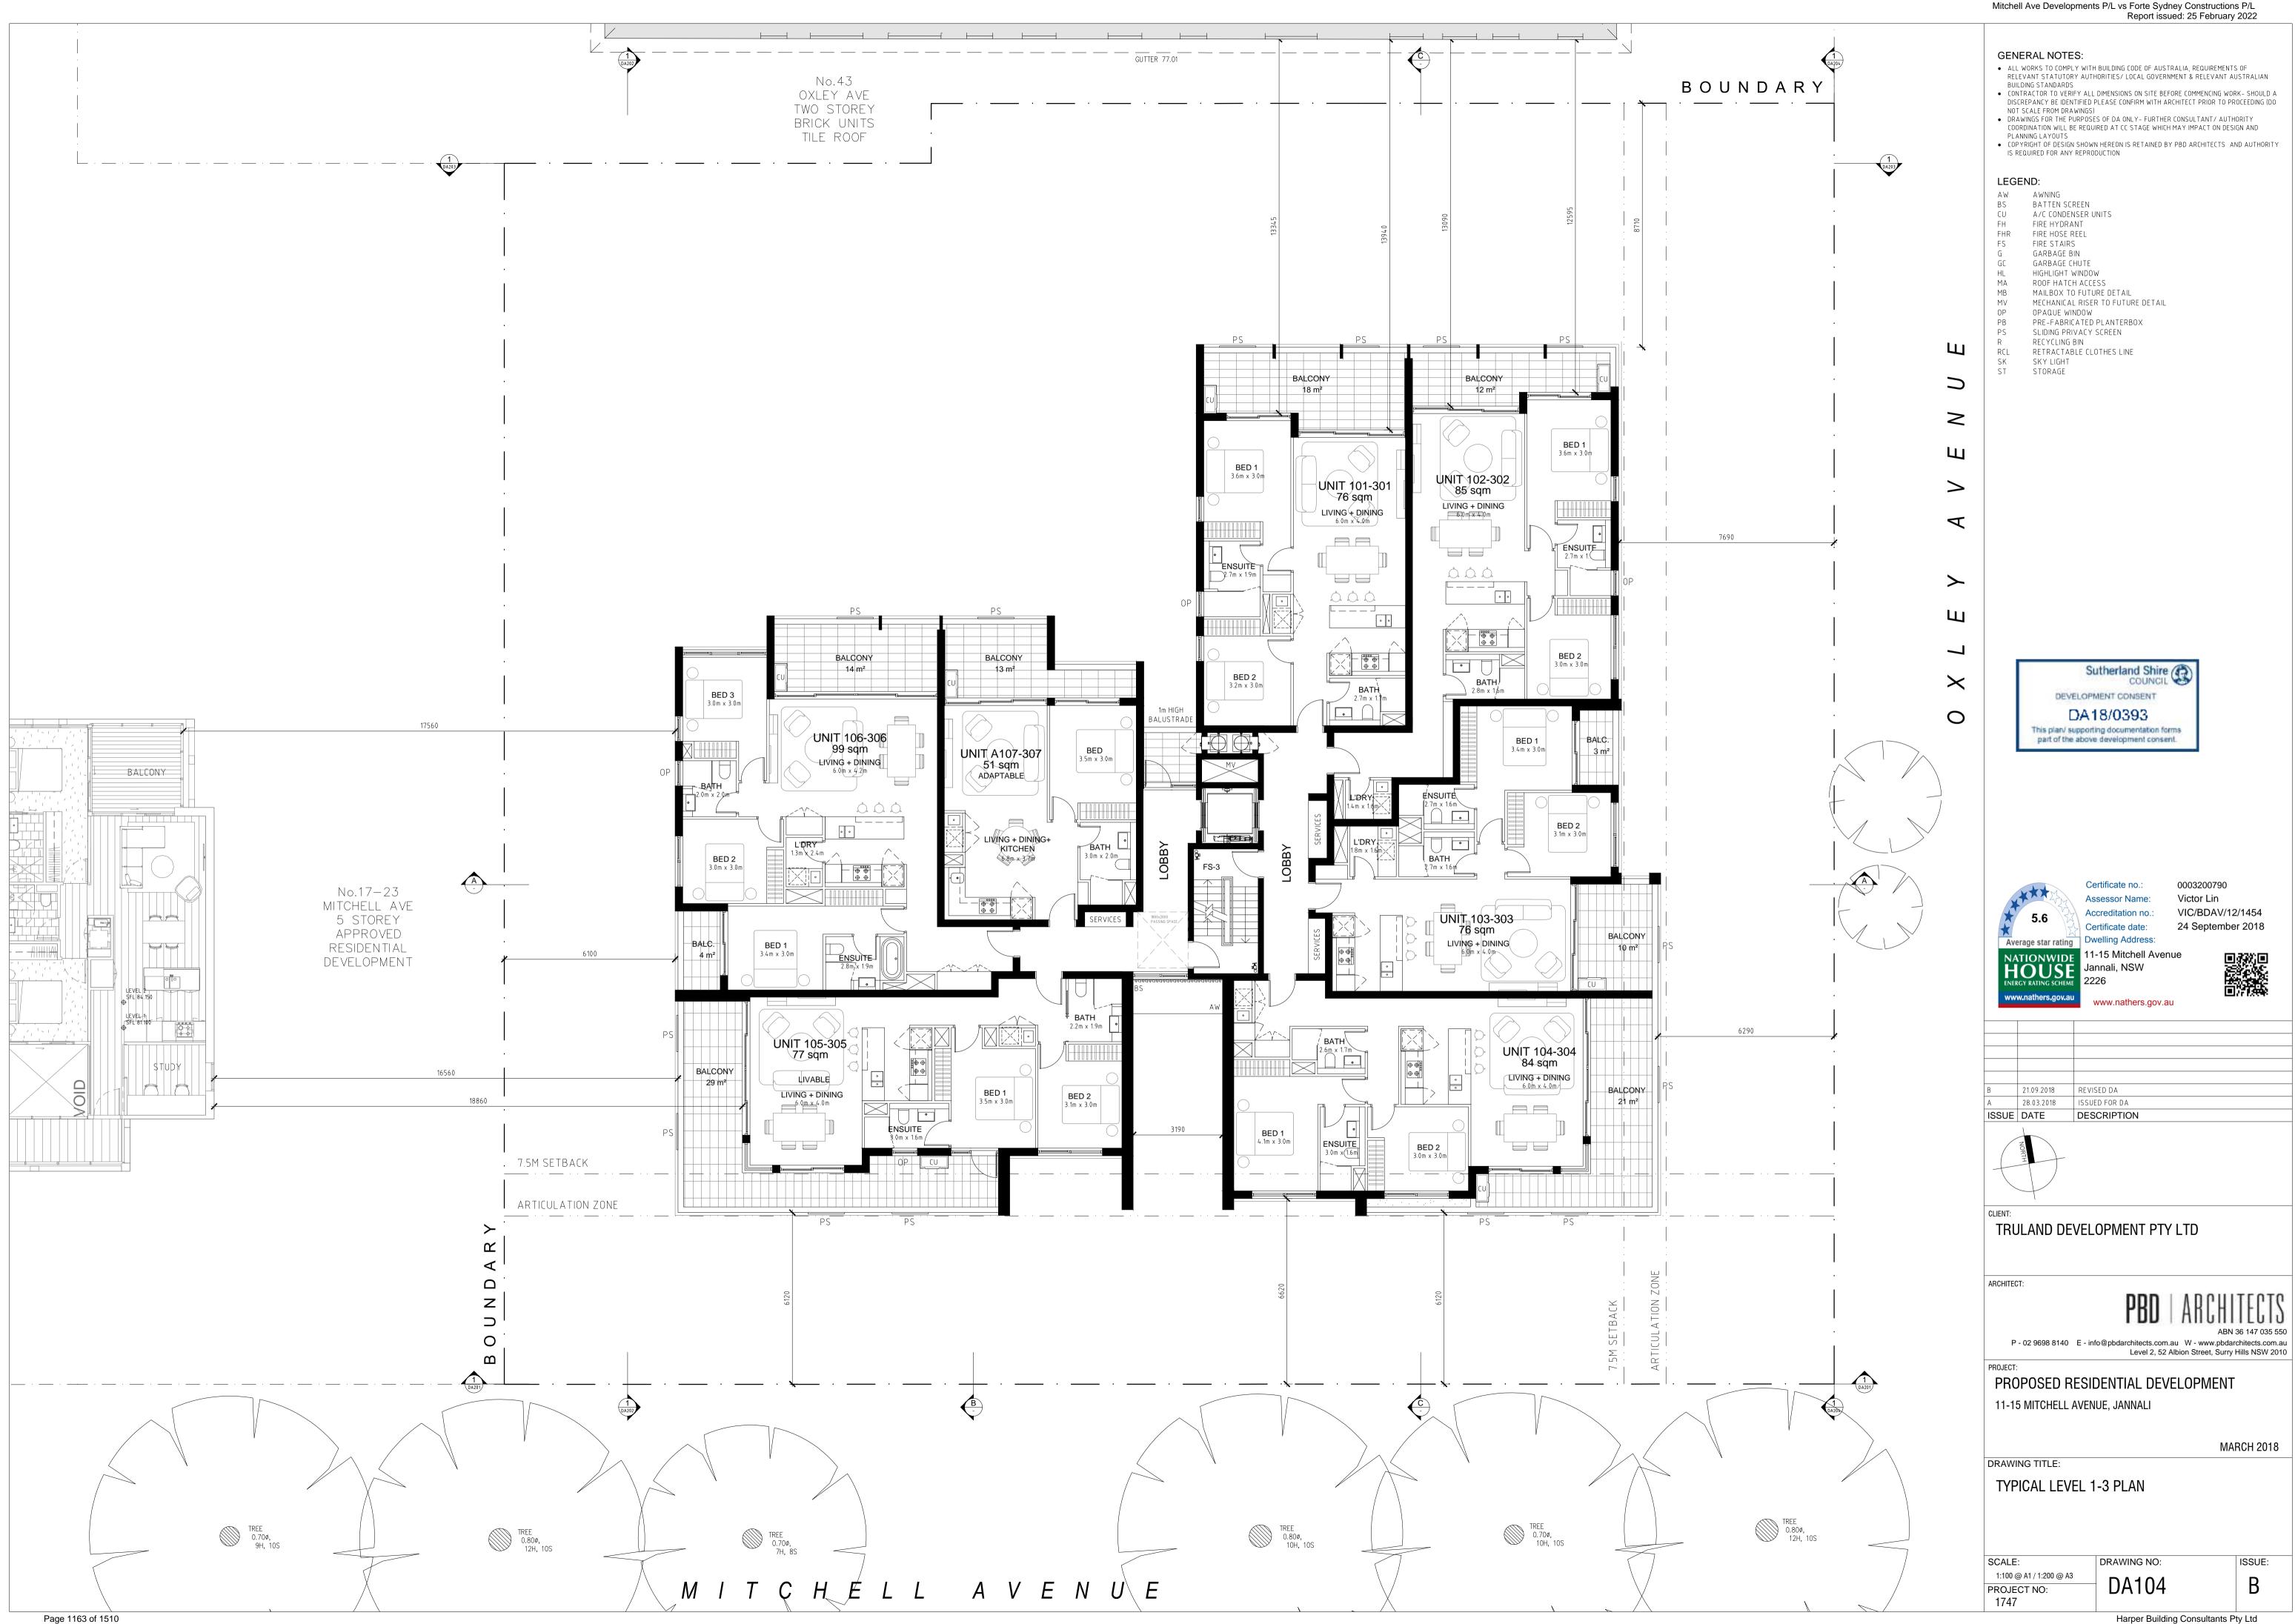


Page 1161 of 1510

Mitchell Ave Developments P/L vs Forte Sydney Constructions P/L Report issued: 25 February 2022




Mitchell Ave Developments P/L vs Forte Sydney Constructions P/L





Page 1164 of 1510

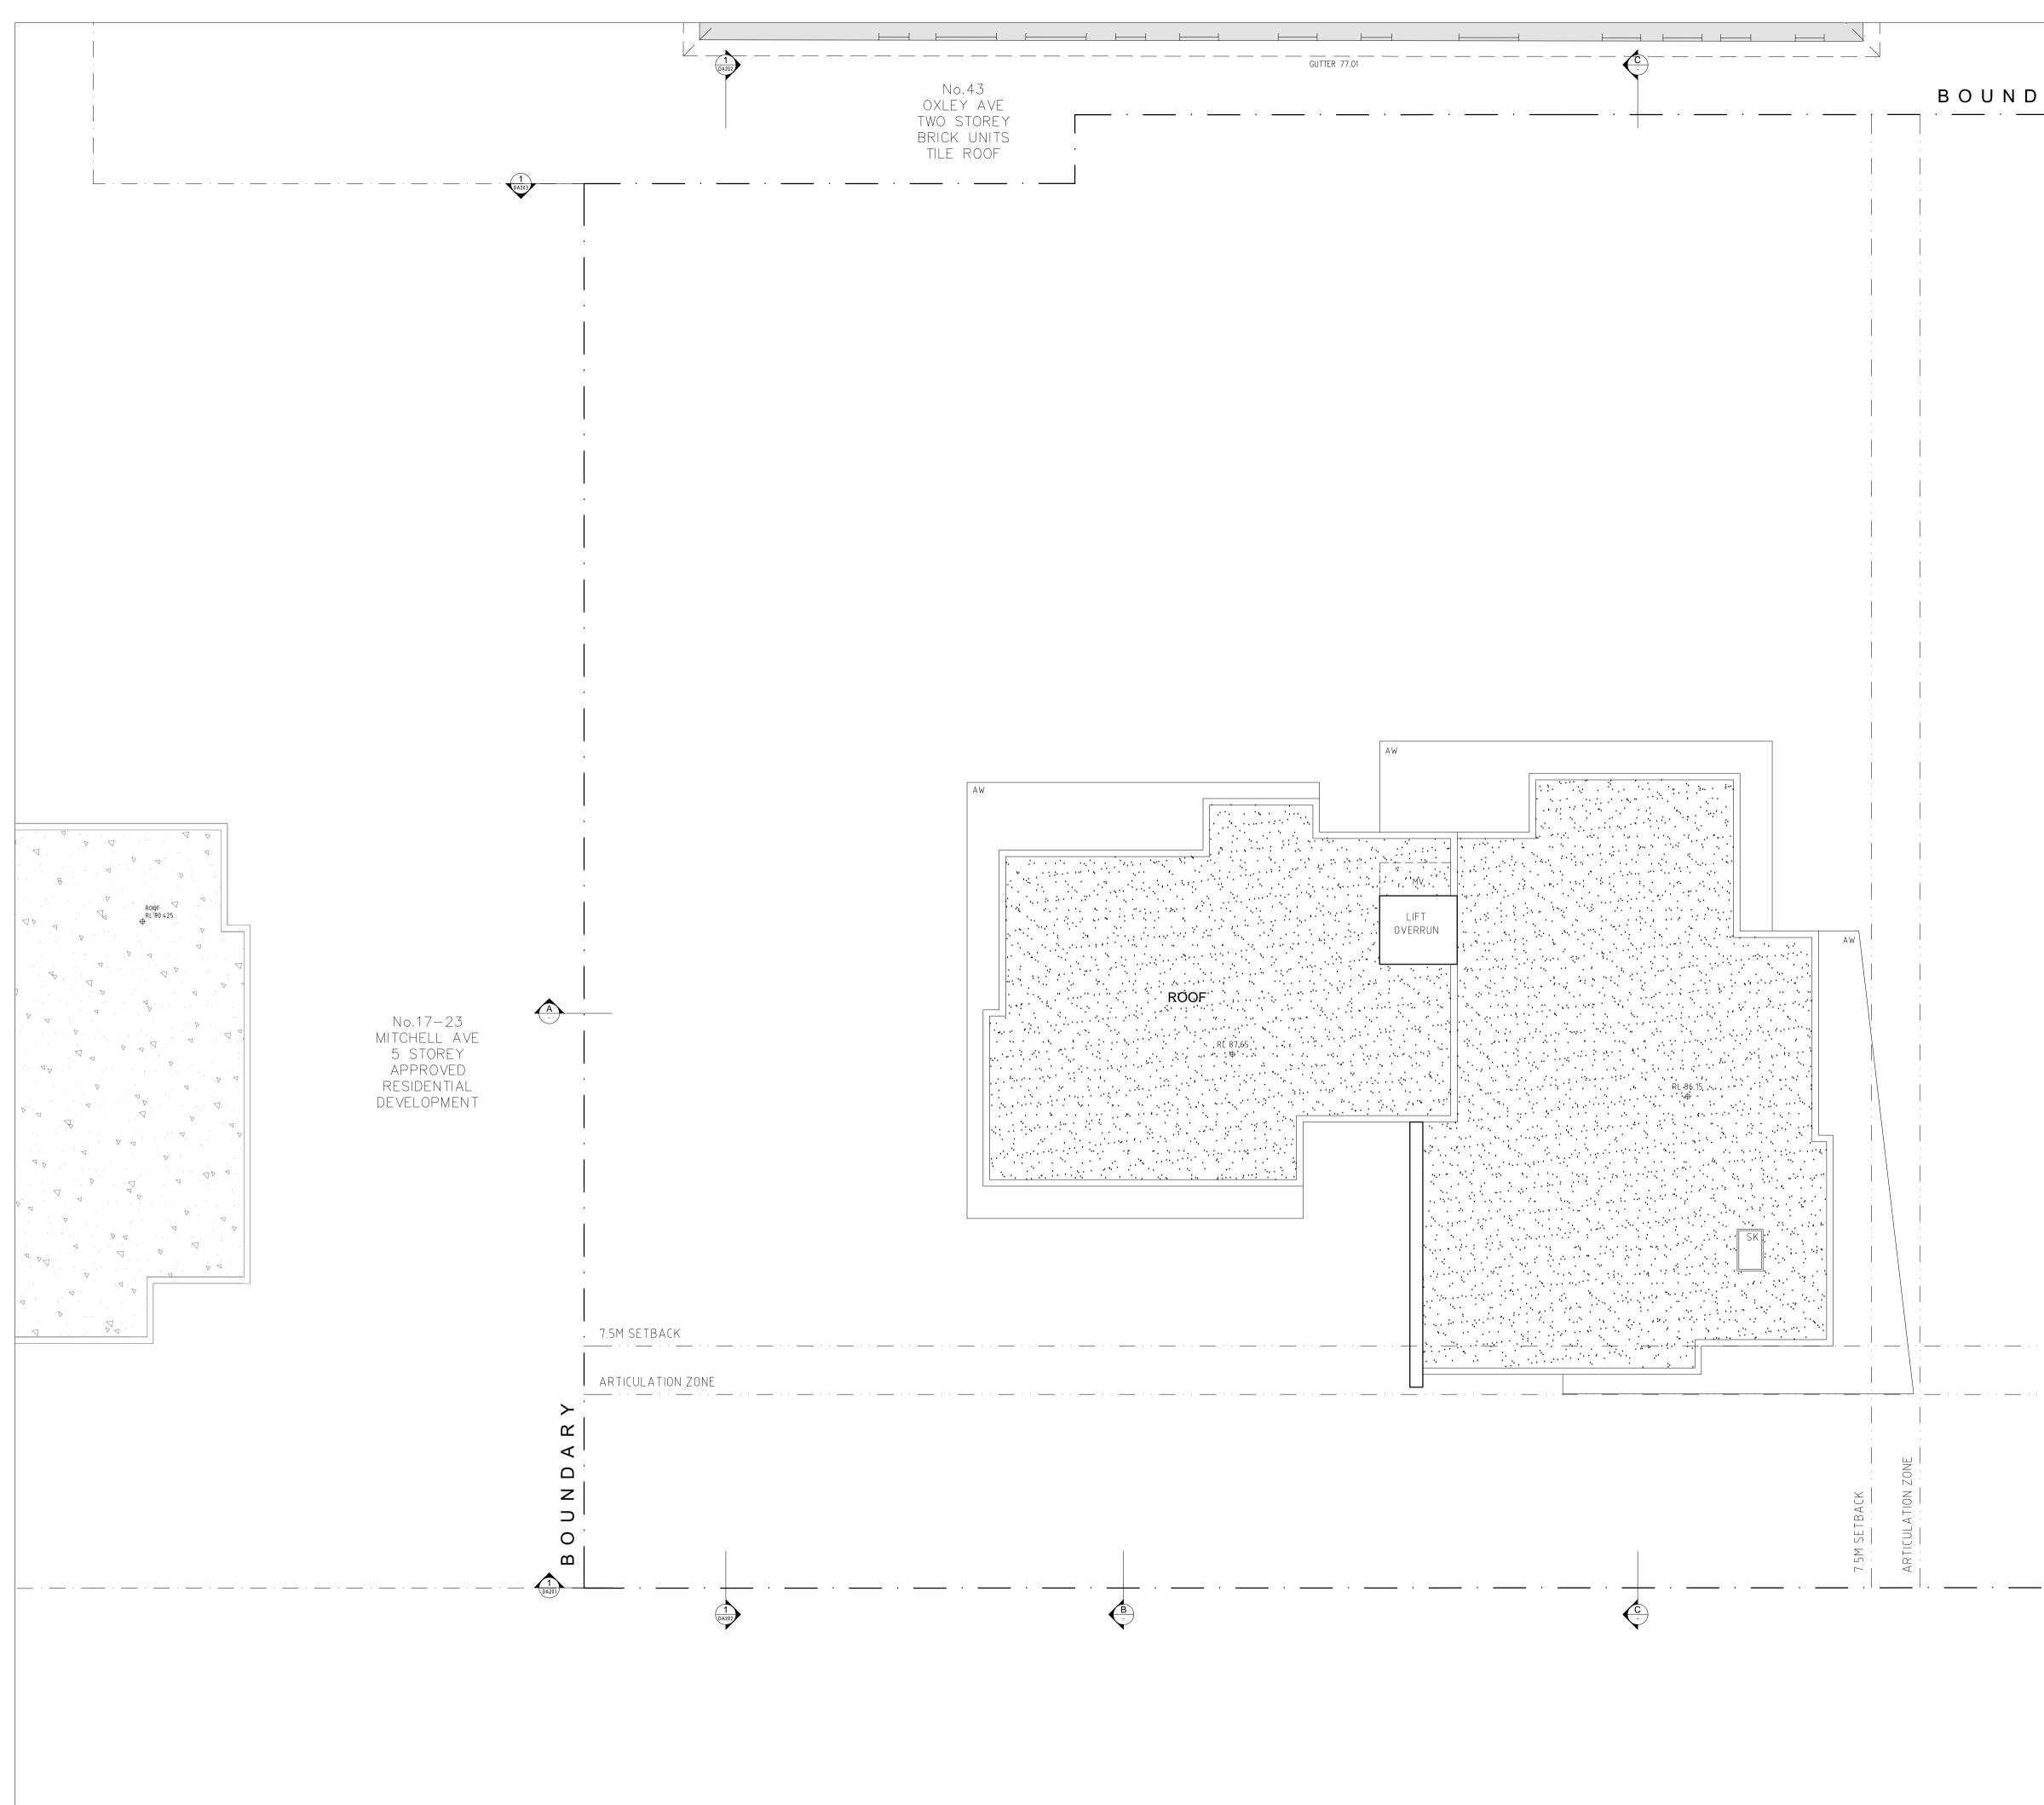

MITCHELL AVENUE

 CENERAL NOTES: ALL WORKS TO COMPLY WITHORITIES/ LOCAL GOVERNMENT & RELEVANT AUSTRALIAN BUILDING STANDARDS CONTRACTOR TO VERIFY ALL DIMENSIONS ON SITE BEFORE COMMENCING WORK - SHOULD A DISCREPANCY BE IDENTIFIED PLEASE CONFIRM WITH ARCHITECT PRIOR TO PROCEEDING (DO NOT SCALE FROM DRAWINGS) DRAWINGS FOR THE PURPOSES OF DA ONLY - FURTHER CONSULTANT / AUTHORITY (CORDINATION WILL BE REQUIRED AT CC STAGE WHICH MAY IMPACT ON DESIGN AND PLANNING LAYOUTS) COPYRIGHT OF DESIGN SHOWN HEREON IS RETAINED BY PBD ARCHITECTS AND AUTHORITY IS REQUIRED FOR ANY REPRODUCTION LEGEND: AW AWNING BS BATTEN SCREEN CU A/C CONDENSER UNITS FHIRE HYDRANT FHIRE HYDRANT FHIRE HYDRANT FHIRE HYDRANT FHIRE HYDRANT FHIRE HYDRANT FHIRE STAIRS G GARBAGE BIN GC GARBAGE BIN GC GARBAGE BIN GC GARBAGE BIN GC GARBAGE DINTE HL HIGHLIGHT WINDOW MA ROOF HATCH ACCESS MB MAILBOX TO FUTURE DETAIL MV MECHANICAL RISER TO FUTURE DETAIL OP OPAQUE WINDOW PB PRE-FABRICATED PLANTERBOX PS SLUDIND RIVACY SCREEN R ECYCLING BIN RCL RETRACTABLE CLOTHES LINE SK SKY LIGHT ST STORAGE
Sutherland Shire COUNCIL DEVELOPMENT CONSENT DA 18/0393 This plan/ supporting documentation forms part of the above development consent.
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B 21.09.2018 REVISED DA A 28.03.2018 ISSUED FOR DA ISSUE DATE DESCRIPTION CLIENT:
ARCHITECT: PROJECT: P - 02 9698 8140 E - info@pbdarchitects.com.au W - www.pbdarchitects.com.au W - www.pbdarchitects.com.au Level 2, 52 Albion Street, Surry Hills NSW 2010 PROPOSED RESIDENTIAL DEVELOPMENT 11-15 MITCHELL AVENUE, JANNALI
MARCH 2018 DRAWING TITLE: ROOF PLAN SCALE: 1:100 @ A1 / 1:200 @ A3 PROJECT NO: 1747

Mitchell Ave Developments P/L vs Forte Sydney Constructions P/L Report issued: 25 February 2022



		ALL REL BUI CON DIS NO OR CO PLA COF IS F LEG AW BS CU FH FHR FS G GC HL MA MB	EVANT STATUTC LDING STANDARD VTRACTOR TO VEI CREPANCY BE IDE I SCALE FROM DR AWINGS FOR THE DRDINATION WILL VINING LAYOUTS PYRIGHT OF DESIG REQUIRED FOR AN END: AWNING BATTEN SI A/C CONDE FIRE HYDR FIRE HOSE FIRE STAIF GARBAGE GARBAGE HIGHLIGHT ROOF HATT MAILBOX T	2LY WITH BUILDING CODE OF AUSTRALIA RY AUTHORITIES/ LOCAL GOVERNMENT S RIFY ALL DIMENSIONS ON SITE BEFORE C NTIFIED PLEASE CONFIRM WITH ARCHITE AWINGS) PURPOSES OF DA ONLY- FURTHER CONS BE REQUIRED AT CC STAGE WHICH MAY IN SHOWN HEREON IS RETAINED BY PBD Y REPRODUCTION CREEN INSER UNITS ANT REEL S BIN CHUTE WINDOW CH ACCESS O FUTURE DETAIL
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- ONLY- FURTHER CONSULTANT/ AUTHORITY CC STAGE WHICH MAY IMPACT ON DESIGN AND
- S RETAINED BY PBD ARCHITECTS AND AUTHORITY
- TURE DETAIL



0003200790 Victor Lin VIC/BDAV/12/1454 24 September 2018



ΟN

CLIENT: TRULAND DEVELOPMENT PTY LTD

ARCHITECT:



PROJECT: PROPOSED RESIDENTIAL DEVELOPMENT 11-15 MITCHELL AVENUE, JANNALI

MARCH 2018

DRAWING TITLE: **ELEVATION - SOUTH**

SCALE:	DRAWING NO:	ISSUE:
1:100 @ A1 / 1:200 @ A3		П
PROJECT NO:	DA201	B
1747		



GENERAL NOTES:

- GENERAL NOTES:
 ALL WORKS TO COMPLY WITH BUILDING CODE OF AUSTRALIA, REQUIREMENTS OF RELEVANT STATUTORY AUTHORITIES/ LOCAL GOVERNMENT & RELEVANT AUSTRALIAN BUILDING STANDARDS
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LEGEND:

- AW AWNING BS BATTEN SCREEN CU A/C CONDENSER UNITS
- FH FIRE HYDRANT FHR FIRE HOSE REEL
- FS FIRE STAIRS
- GARBAGE BIN G GARBAGE CHUTE GC
- HIGHLIGHT WINDOW HL MA
- ROOF HATCH ACCESS MAILBOX TO FUTURE DETAIL MECHANICAL RISER TO FUTURE DETAIL MB MV
- OPAQUE WINDOW PRE-FABRICATED PLANTERBOX OP
- РB
- SLIDING PRIVACY SCREEN R RECYCLING BIN RCL RETRACTABLE CLOTHES LINE SK SKY LIGHT ST STORAGE



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Sutherland Shire

DEVELOPMENT CONSENT DA18/0393



21.09.2018 REVISED DA 28.03.2018 ISSUED FOR DA ISSUE DATE DESCRIPTION

CLIENT: TRULAND DEVELOPMENT PTY LTD

ARCHITECT:



PROJECT: PROPOSED RESIDENTIAL DEVELOPMENT 11-15 MITCHELL AVENUE, JANNALI

MARCH 2018

ELEVATION - WEST

DRAWING TITLE:

SCALE:	DRAWING NO:	ISSUE:
1:100 @ A1 / 1:200 @ A3		
PROJECT NO:	DA202	B
1747		



Mitchell Ave Developments P/L vs Forte Sydney Constructions P/L Report issued: 25 February 2022

GENERAL NOTES:

- ALL WORKS TO COMPLY WITH BUILDING CODE OF AUSTRALIA, REQUIREMENTS OF RELEVANT STATUTORY AUTHORITIES/ LOCAL GOVERNMENT & RELEVANT AUSTRALIAN BUILDING STANDARDS
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- PLANNING LAYOUTS
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LEGEND:

- AW AWNING ΒS BATTEN SCREEN
- CU A/C CONDENSER UNITS FIRE HYDRANT FH
- FHR FIRE HOSE REEL FS FIRE STAIRS
- GARBAGE BIN G GARBAGE CHUTE GC HIGHLIGHT WINDOW
- HL MA MB
- ROOF HATCH ACCESS MAILBOX TO FUTURE DETAIL MECHANICAL RISER TO FUTURE DETAIL MV OP
- OPAQUE WINDOW PRE-FABRICATED PLANTERBOX РB ΡS
 - SLIDING PRIVACY SCREEN RECYCLING BIN RETRACTABLE CLOTHES LINE
- R RCL SK ST SKY LIGHT STORAGE

DEVELOPMENT CONSENT DA18/0393 This plan/ supporting documentation forms part of the above development consent.

Sutherland Shire

COUNCIL CO

Certificate no.: 0003200790 Assessor Name: Victor Lin VIC/BDAV/12/1454 Accreditation no.: Certificate date: Dwelling Address: 11-15 Mitchell Avenue HOUSE 11-15 Mitchell A Jannali, NSW

24 September 2018



21.09.2018 REVISED DA 28.03.2018 ISSUED FOR DA ISSUE DATE DESCRIPTION

www.nathers.gov.au

CLIENT: TRULAND DEVELOPMENT PTY LTD

2226

ARCHITECT:

14

5.6

Average star rating

NERGY RATING SCHEM

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PROJECT: PROPOSED RESIDENTIAL DEVELOPMENT 11-15 MITCHELL AVENUE, JANNALI

DRAWING TITLE:

MARCH 2018

ELEVATION - NORTH

SCALE:	DRAWING NO:	ISSUE:
1:100 @ A1 / 1:200 @ A3		D
PROJECT NO:	DA203	D
1747		



GENERAL NOTES:

- ALL WORKS TO COMPLY WITH BUILDING CODE OF AUSTRALIA, REQUIREMENTS OF RELEVANT STATUTORY AUTHORITIES/ LOCAL GOVERNMENT & RELEVANT AUSTRALIAN BUILDING STANDARDS
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- PLANNING LAYOUTS
 COPYRIGHT OF DESIGN SHOWN HEREON IS RETAINED BY PBD ARCHITECTS AND AUTHORITY IS REQUIRED FOR ANY REPRODUCTION

LEGEND:

- AW AWNING ΒS BATTEN SCREEN CU A/C CONDENSER UNITS
- FH FIRE HYDRANT
- FHR FIRE HOSE REEL FS FIRE STAIRS GARBAGE BIN
- G GARBAGE CHUTE GC HIGHLIGHT WINDOW
- HL MA
- ROOF HATCH ACCESS MAILBOX TO FUTURE DETAIL MECHANICAL RISER TO FUTURE DETAIL MB MV
- OPAQUE WINDOW PRE-FABRICATED PLANTERBOX OP РB
- SLIDING PRIVACY SCREEN ΡS R
 - RECYCLING BIN RETRACTABLE CLOTHES LINE
- RCL SK ST SKY LIGHT STORAGE



DEVELOPMENT CONSENT DA18/0393

Sutherland Shire





CLIENT: TRULAND DEVELOPMENT PTY LTD

ARCHITECT:




PROJECT: PROPOSED RESIDENTIAL DEVELOPMENT 11-15 MITCHELL AVENUE, JANNALI

MARCH 2018

ELEVATION - EAST

DRAWING TITLE:

SCALE:	DRAWING NO:	ISSUE:
1:100 @ A1 / 1:200 @ A3		П
PROJECT NO:	DA204	В
1747		

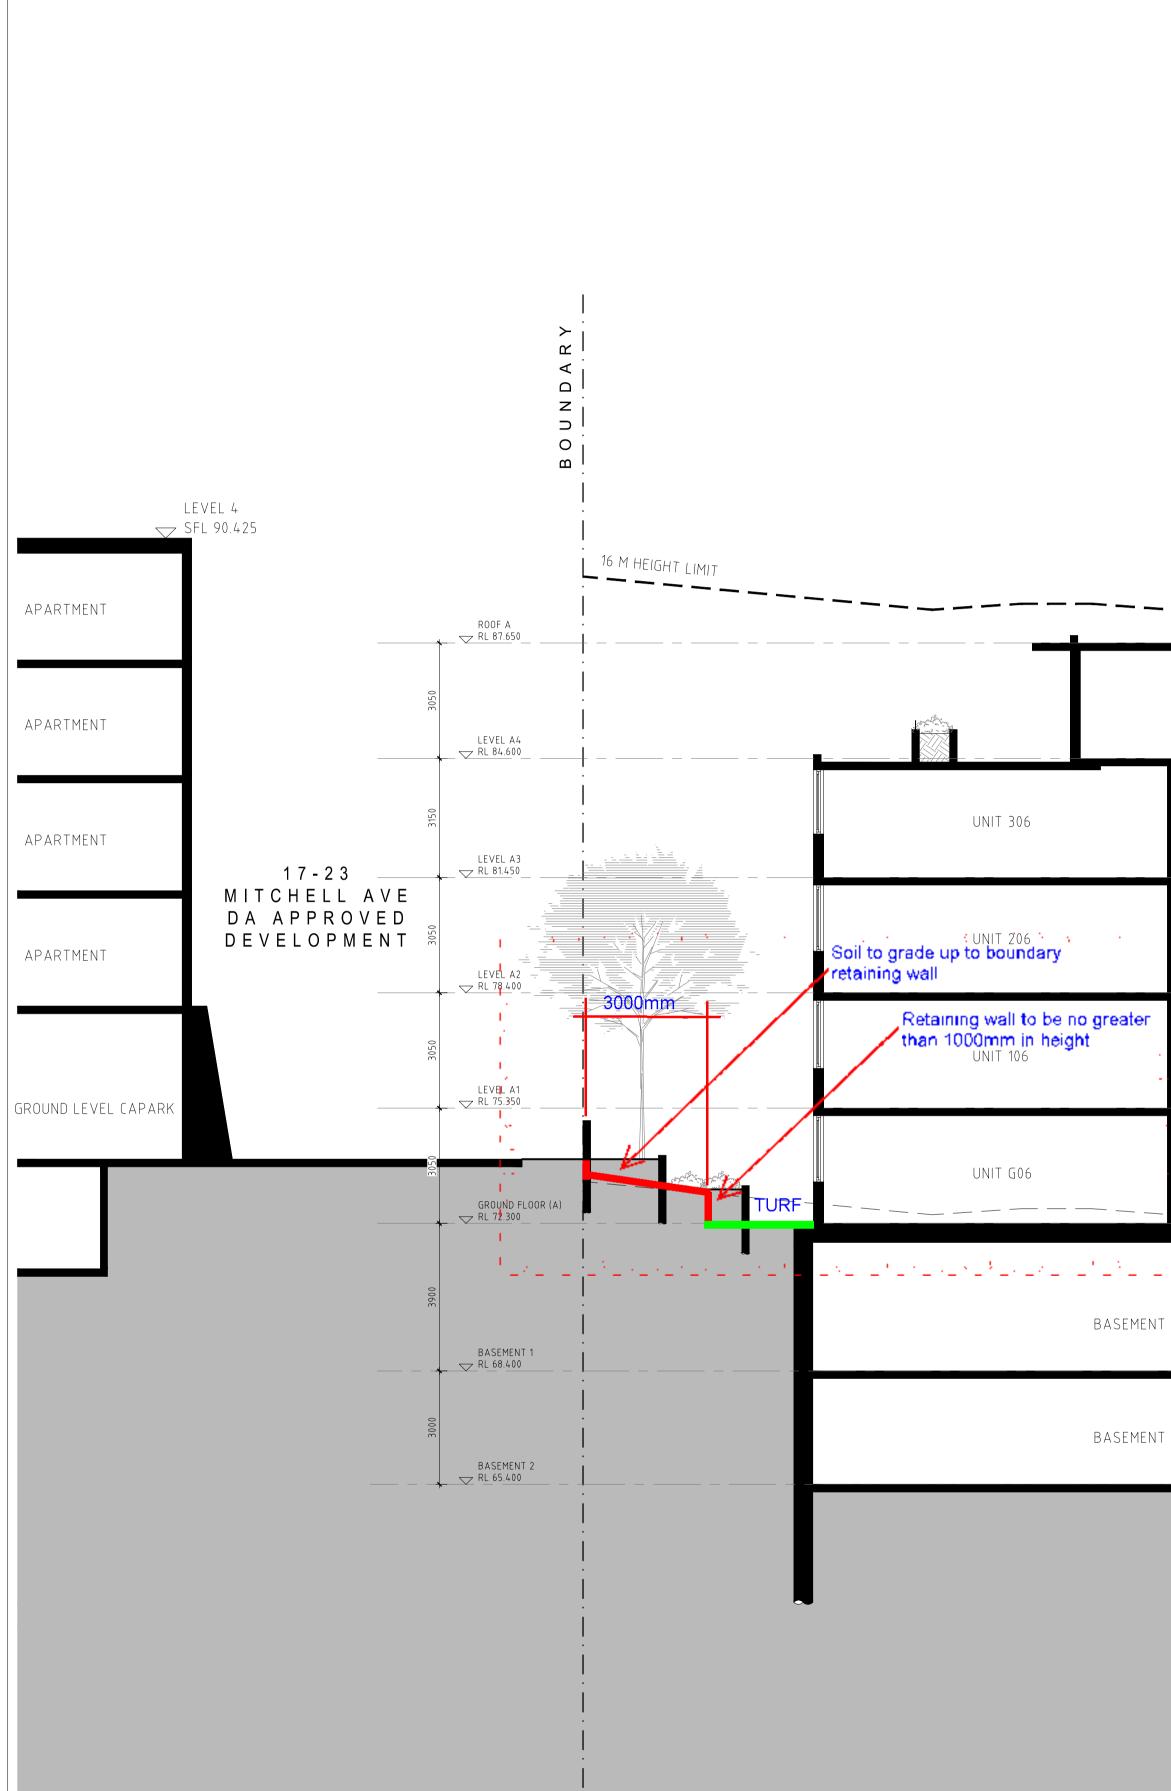


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UNIT 307	LOBBY		LOBBY	UNIT 401		
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LEVEL 4 RL 83.100		
LEVEL 3		
LEVEL 2		
RL 76.900	DEVELOPMENT CONSENT DA 18/0393	
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3050 8		
GROUND FLOOR RL 70.800		
BASEMENT 1 RL 67.800	Image: Market State Image: Market State	
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BASEMENT 2 RL 64.800	CLIENT:	
	TRULAND DEVELOPMENT PTY LTD	
	ARCHITECT: PBD ARCHITECTS ABN 36 147 035 550	
	ABN 36 147 035 550 P - 02 9698 8140 E - info@pbdarchitects.com.au W - www.pbdarchitects.com.au Level 2, 52 Albion Street, Surry Hills NSW 2010 PROJECT: PROPOSED RESIDENTIAL DEVELOPMENT 11-15 MITCHELL AVENUE, JANNALI	
	MARCH 2018 DRAWING TITLE: SECTION AA	

BOUNDARY

SCALE:	DRAWING NO:	ISSUE:
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PROJECT NO:	DA301	В
1747		
	Harper Building Consultants P	ty Ltd

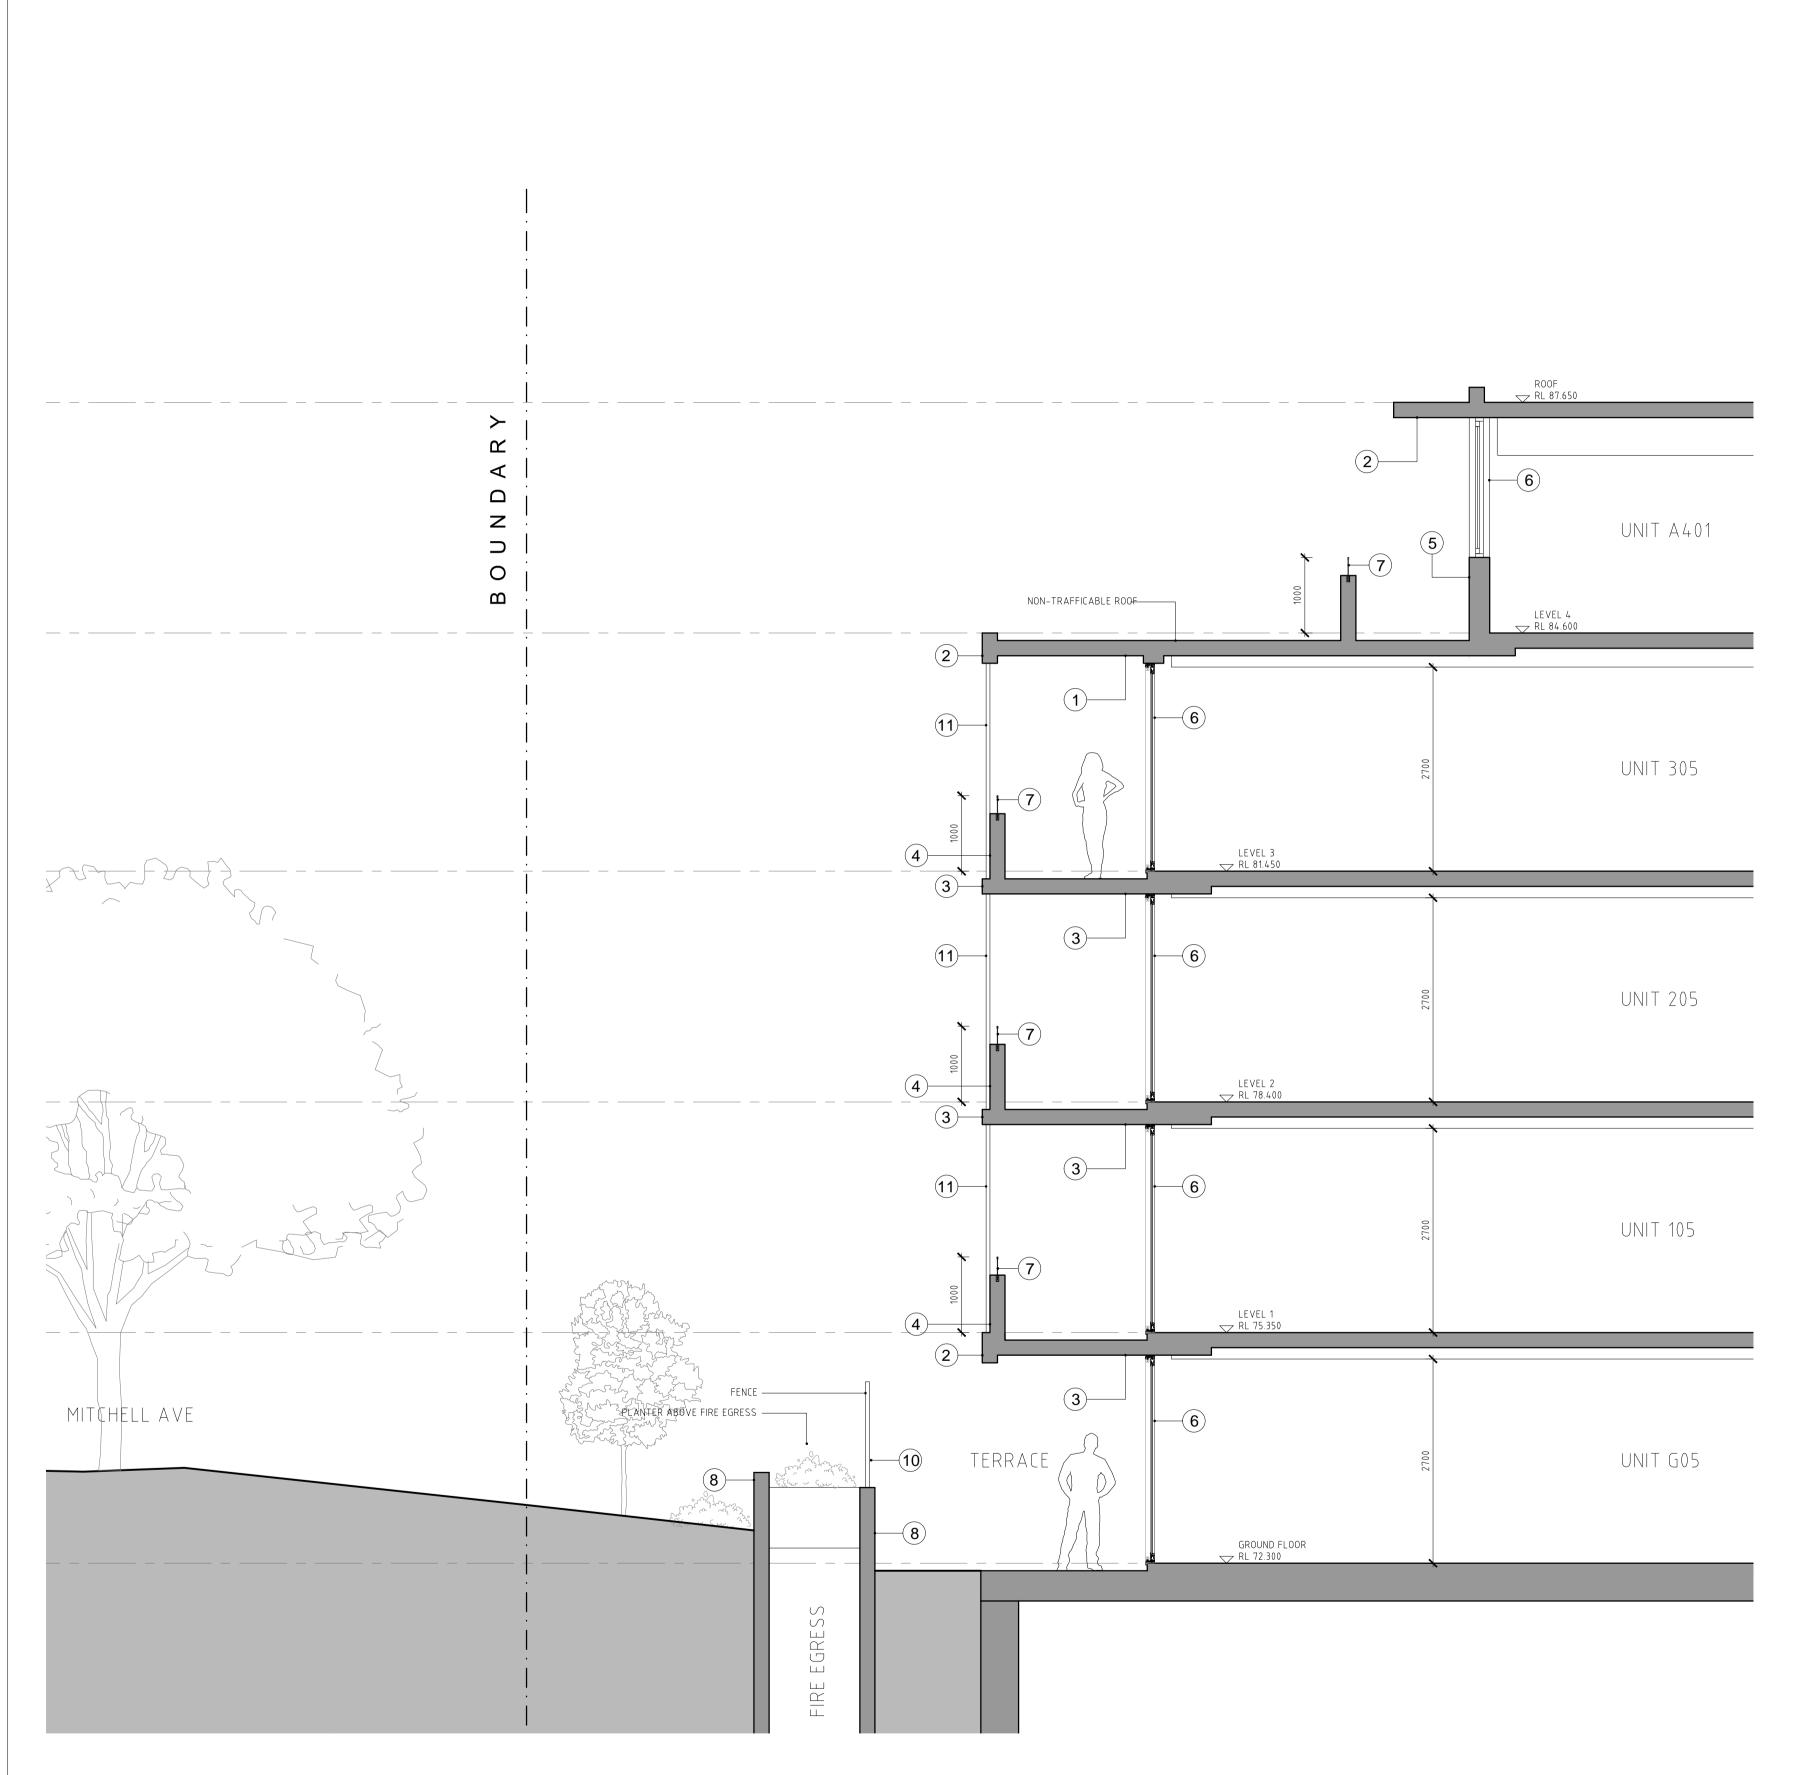

LEGEND


- TIMBER SOFFIT 1.
- 2. RENDERED SLAB EDGE / PAINTED SOFFIT DULUX WESTERN MYALL or similar
- RENDERED SLAB EDGE / PAINTED SOFFIT DULUX NATURAL WHITE or similar 3.
- RENDERED BALUSTRADE UPTURN (760mm) DULUX MILTON MOON or similar 4.
- RENDERED WALL in DULUX WESTERN MYALL or similar 5.
- GLAZING TYPE POWDERCOATED DARK GREY MATT or similar 6.
- HANDRAIL MATERIAL 240mm FRAMELESS GLASS 7.
- MASONRY WALL 1 RENDERED DULUX NATURAL WHITE or similar 8.
- MASONRY WALL 2 SANDSTONE CLADDING 9.
- METAL FENCE 10.
- 11. SLIDING PRIVACY SCREENS

		Report iss	sued: 25 Februar	y 2022
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	This plan/ s	Sutherland Shire COUNCIL PELOPMENT CONSENT DA18/0393 Supporting documentation for a above development conse	rms	
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B A ISSU	21.09.2018 28.03.2018 DATE	REVISED DA ISSUED FOR DA DESCRIPTION		
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DA302

Harper Building Consultants Pty Ltd

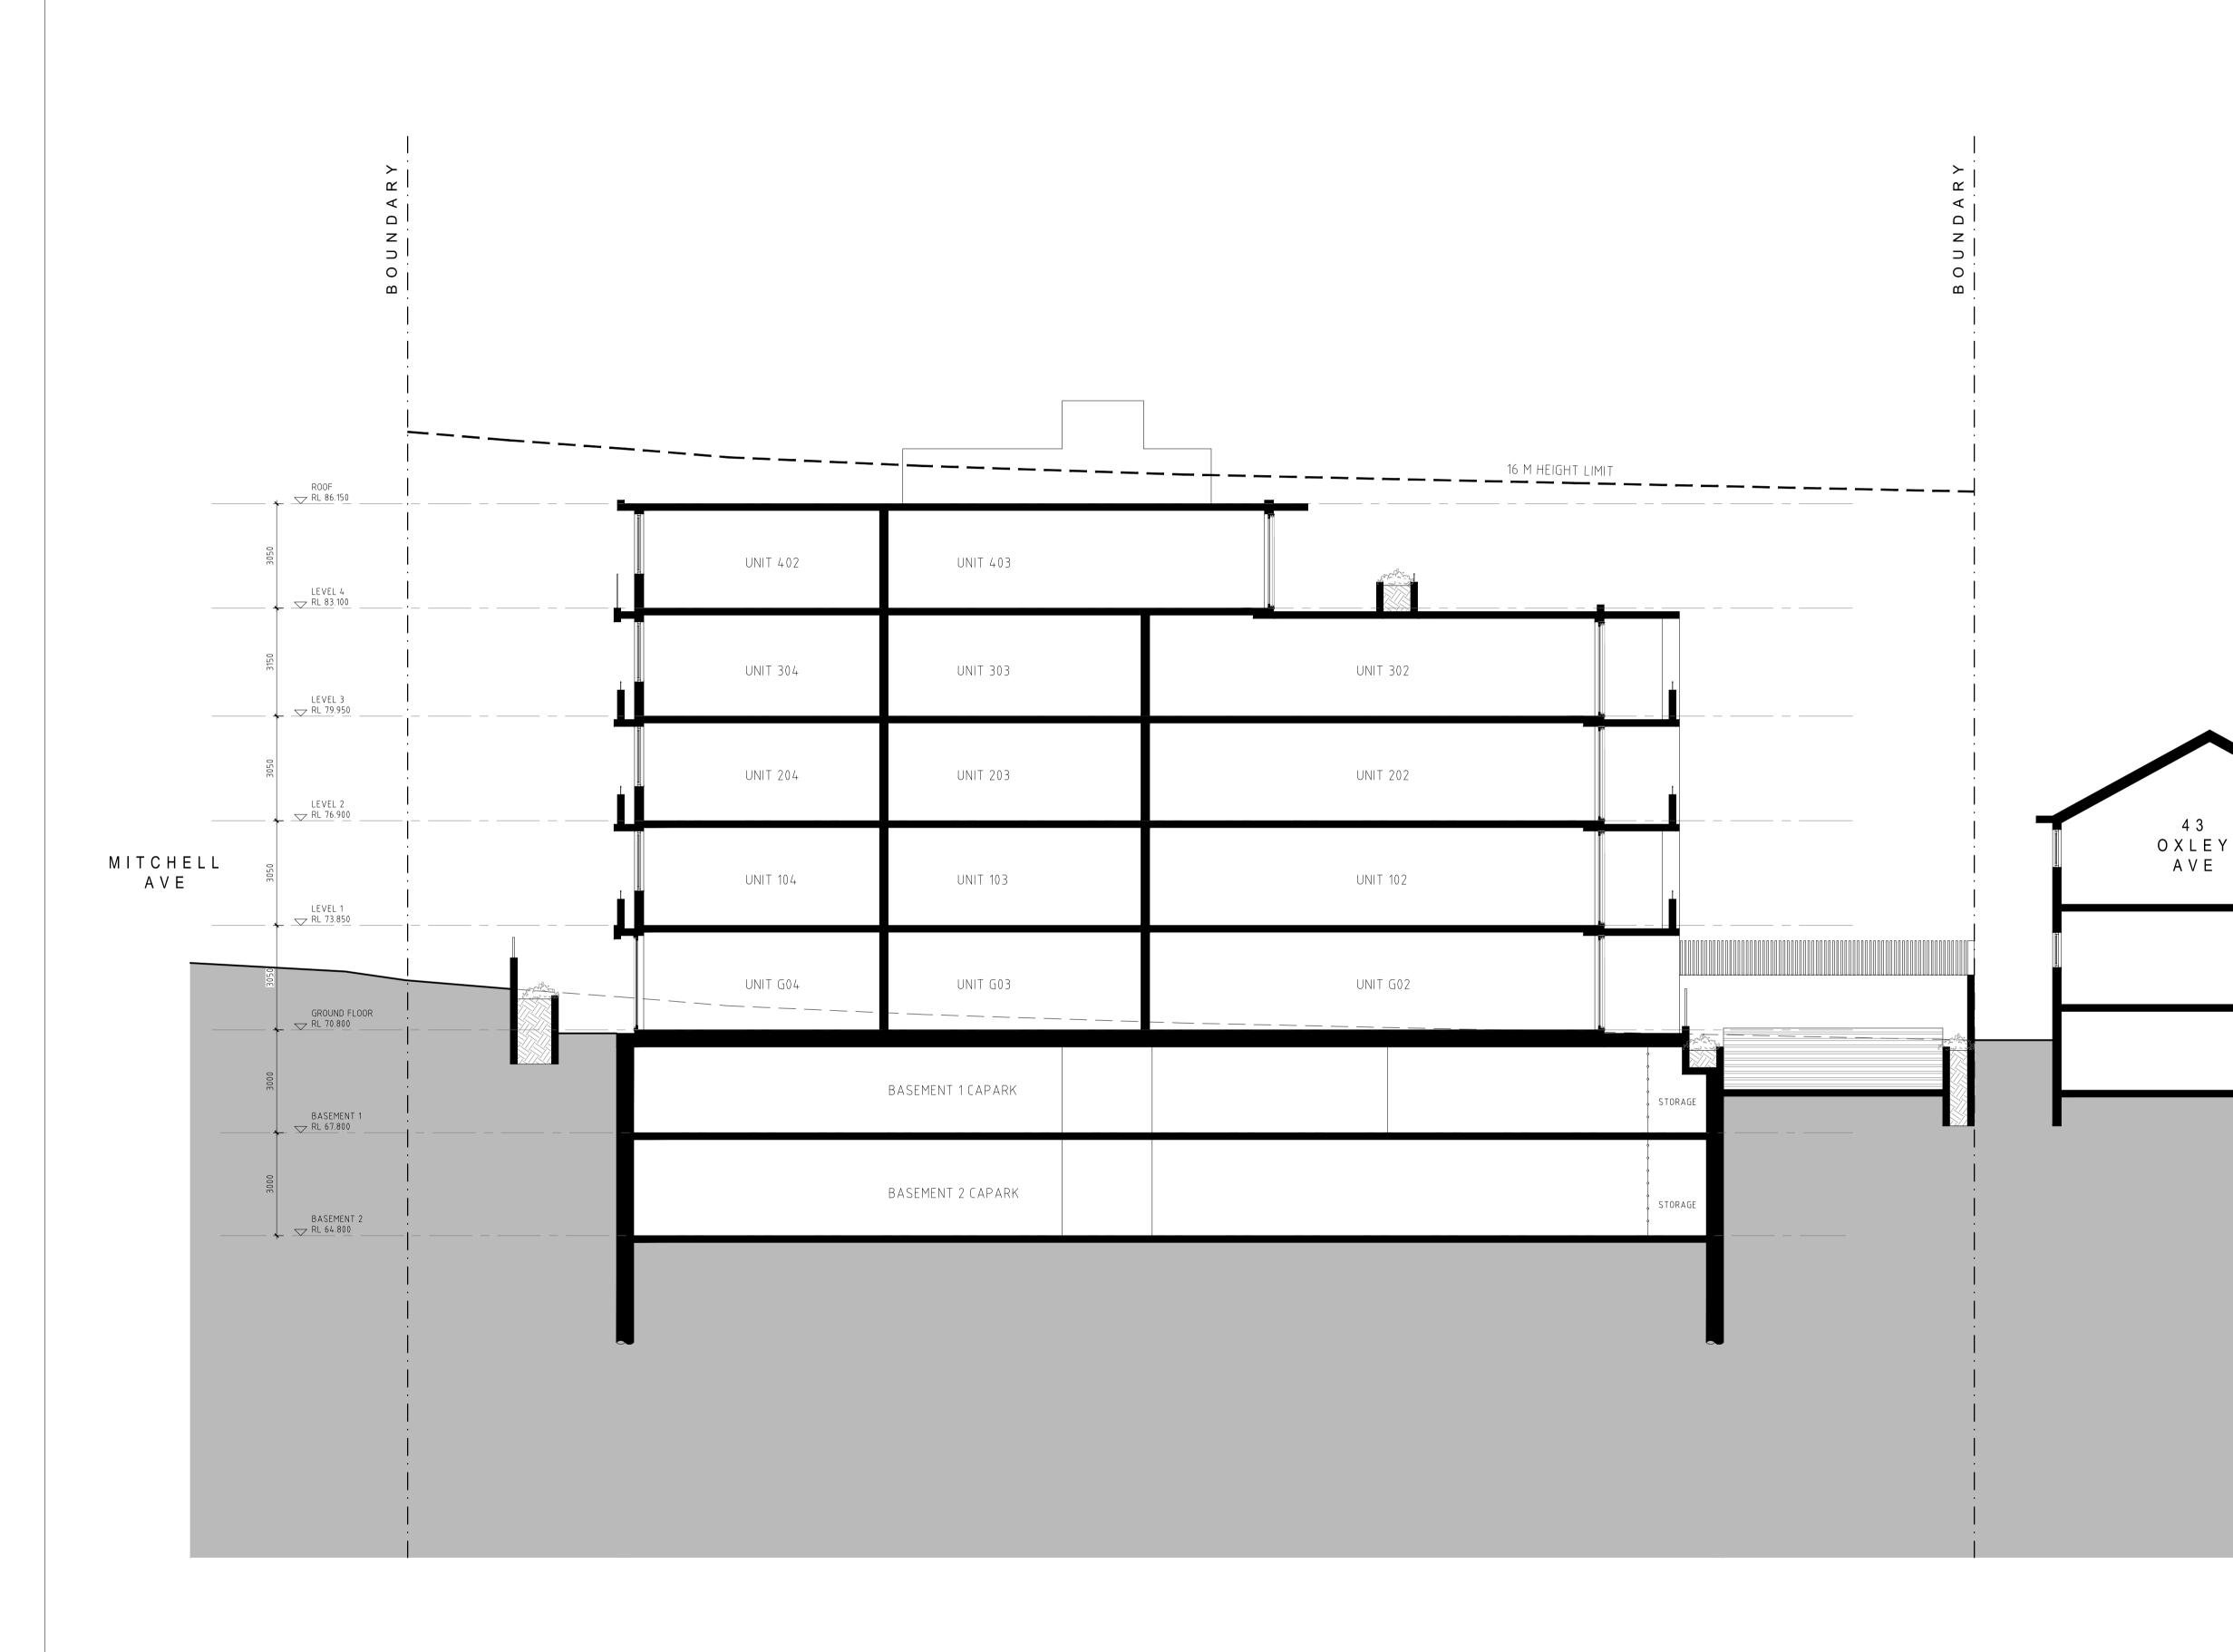PROJECT NO: 1747








1 SOUTH ELEVATION - SCALE 1 : 100 @ A1



2 WEST ELEVATION - SCALE 1 : 100 @ A1

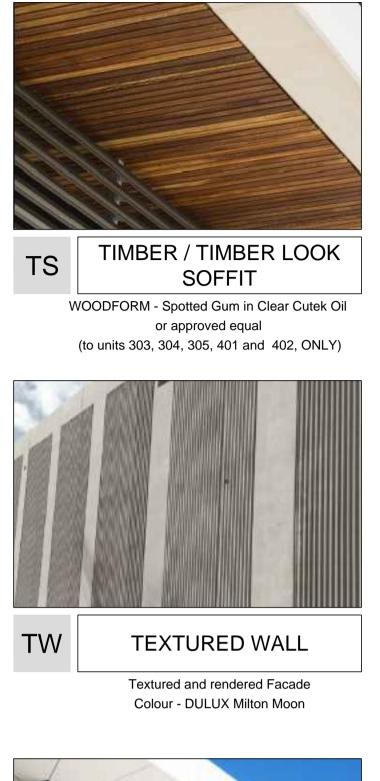Page 1173 of 1510













MF	METAL FENCE	RW

P1	DULUX NATURAL WHITE (SW1F4) OR EQUAL			
P2	DULUX WESTERN MYALL (PG1F7) OR EQUAL			
P3	DULUX MILTON MOON (PN2G5) OR EQUAL			
P4	DULUX LINSEED (S15B3) OR EQUAL			
	DULUX POWDERCOAT DARK GREY MATT (90051275)			
Aluminium Extrusions, Awnings, Door and WIndow frames				

Mitchell Ave Developments P/L vs Forte Sydney Constructions P/L Report issued: 25 February 2022

GENERAL NOTES:

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- PLANNING LAYOUTS
 COPYRIGHT OF DESIGN SHOWN HEREON IS RETAINED BY PBD ARCHITECTS AND AUTHORITY IS REQUIRED FOR ANY REPRODUCTION

LEGEND:

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- AW AWNING BATTEN SCREEN BS
- FH FIRE HYDRANT FHR FIRE HOSE REEL
- FS FIRE STAIRS GARBAGE BIN
 - GARBAGE CHUTE GRATED DRAIN TO HYDRAULIC ENGINEERS DETAILS
- GD GREEN WASTE BIN GW
- HIGHLIGHT WINDOW ROOF HATCH ACCESS ΗL MA
- MAILBOX TO FUTURE DETAIL MB
- MECHANICAL RISER TO FUTURE DETAIL PLANTERBOX LANDSCAPE TO LANDSCAPE ARCHITECTS DETAIL MV
 - SLIDING PRIVACY SCREEN
- PB PS PS2 R RCL ELLIPTICAL PRIVACY SCREEN RECYCLING BIN
 - RETRACTABLE CLOTHES LINE RENDERED WALL
- RW SK ST
 - SKY LIGHT STORAGE



PRIVACY SCREEN

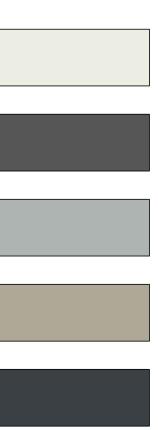
Timber look

Sliding Privacy Screens

To street facing planter walls

WOODFORM Concept Click Battern or similar

RENDERED WALL



		Sutherland Shire	
	D	COUNCIL	
		DA18/0393	
		v supporting documentation forms the above development consent.	
	partici	the above development consent.	
	5.6 Verage star ratin ATIONWID HOUS IERGY RATING SCHE WW.nathers.gov.	Assessor Name: Victo Accreditation no.: VIC/E Certificate date: 24 So Dwelling Address: 11-15 Mitchell Avenue Jannali, NSW 2226	200790 r Lin 3DAV/12/1454 eptember 2018
vv	ww.nathers.gov.	www.nathers.gov.au	
В	21.09.2018	REVISED DA	
A ISSUE	28.03.2018 DATE	ISSUED FOR DA	
CLIENT: TRU	JLAND DE	VELOPMENT PTY LTD	
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Ρ	- 02 9698 8140	E - info@pbdarchitects.com.au W - w Level 2, 52 Albion Stre	
)POSED R	ESIDENTIAL DEVELOPN AVENUE, JANNALI	MENT
			JUNE 2017
DRAW	ING TITLE:		
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PROJECT NO:	DA401	D
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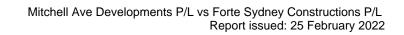








٨F	METAL FENCE	R



GENERAL NOTES:

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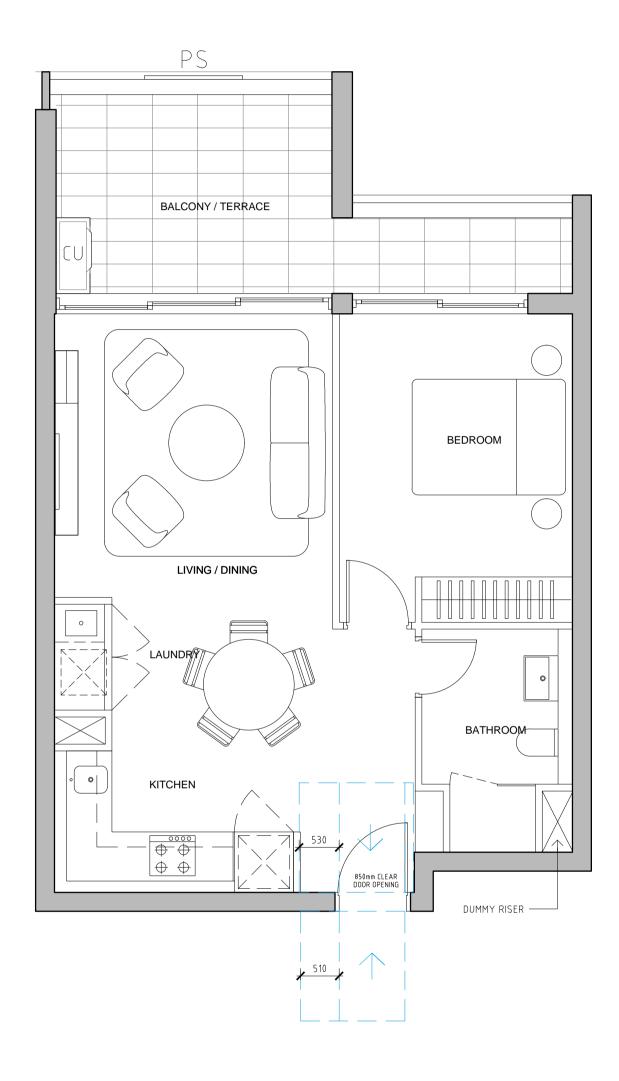
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- AW AWNING BS BATTEN SCREEN
- FH FIRE HYDRANT FHR FIRE HOSE REEL
- FS FIRE STAIRS GARBAGE BIN
 - GARBAGE CHUTE
- GRATED DRAIN TO HYDRAULIC ENGINEERS DETAILS GD GREEN WASTE BIN GW
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- MB MAILBOX TO FUTURE DETAIL
- MECHANICAL RISER TO FUTURE DETAIL PLANTERBOX LANDSCAPE TO LANDSCAPE ARCHITECTS DETAIL MV PB PS PS2
 - SLIDING PRIVACY SCREEN
- ELLIPTICAL PRIVACY SCREEN R RECYCLING BIN
- RCL RETRACTABLE CLOTHES LINE RENDERED WALL
- RW SK ST SKY LIGHT
 - STORAGE

		Sutherland Shire		
	D	EVELOPMENT CONSENT		
		DA18/0393 / supporting documentation forms		
	part of	the above development consent.		
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SSUE	21.09.2018 28.03.2018 DATE	REVISED DA ISSUED FOR DA DESCRIPTION		
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TRULAND DEVELOPMENT PTY LTD				
ARCHITEC	- 02 9698 8140	E - info@pbdarchitects.com.au W - www.p		
Level 2, 52 Albion Street, Surry Hills NSW 2010 PROJECT: PROPOSED RESIDENTIAL DEVELOPMENT 13-15 MITCHELL AVENUE, JANNALI				
			JUNE 2017	
DRAWING TITLE: MATERIALS SCHEDULE NORTH AND EAST ELEVATION				


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1705			


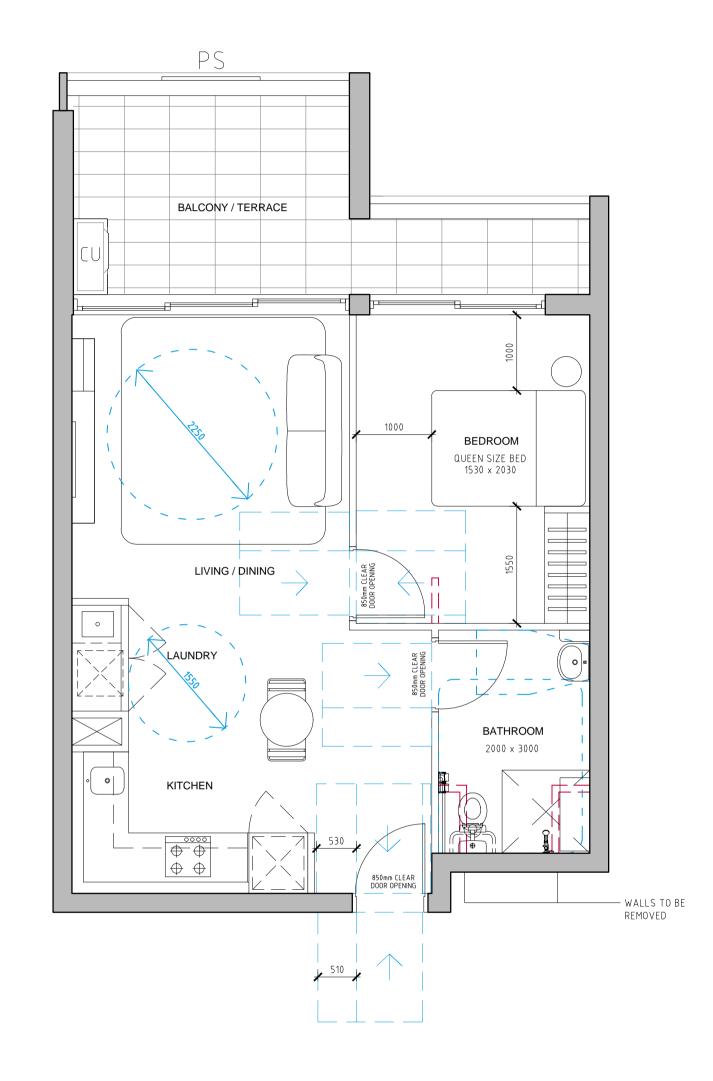
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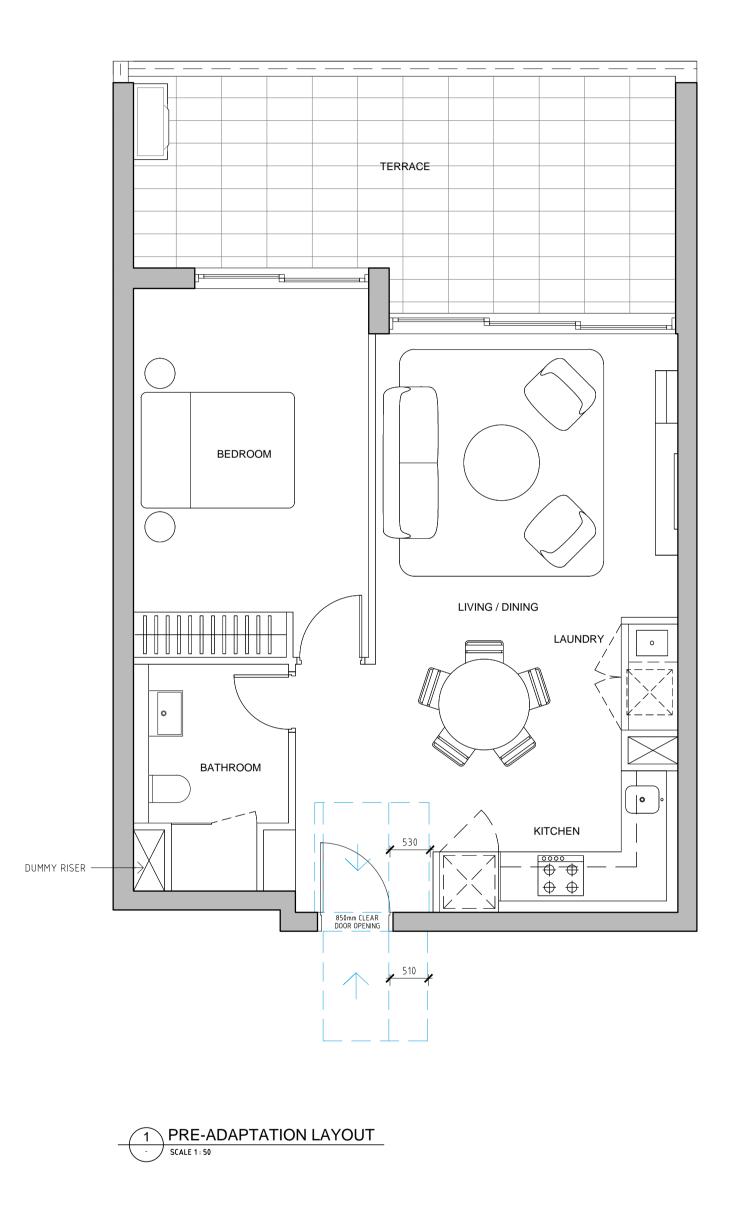
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UNIT G07 UNIT 107 UNIT 207 UNIT 307




2 POST-ADAPTATION LAYOUT · SCALE 1 : 50






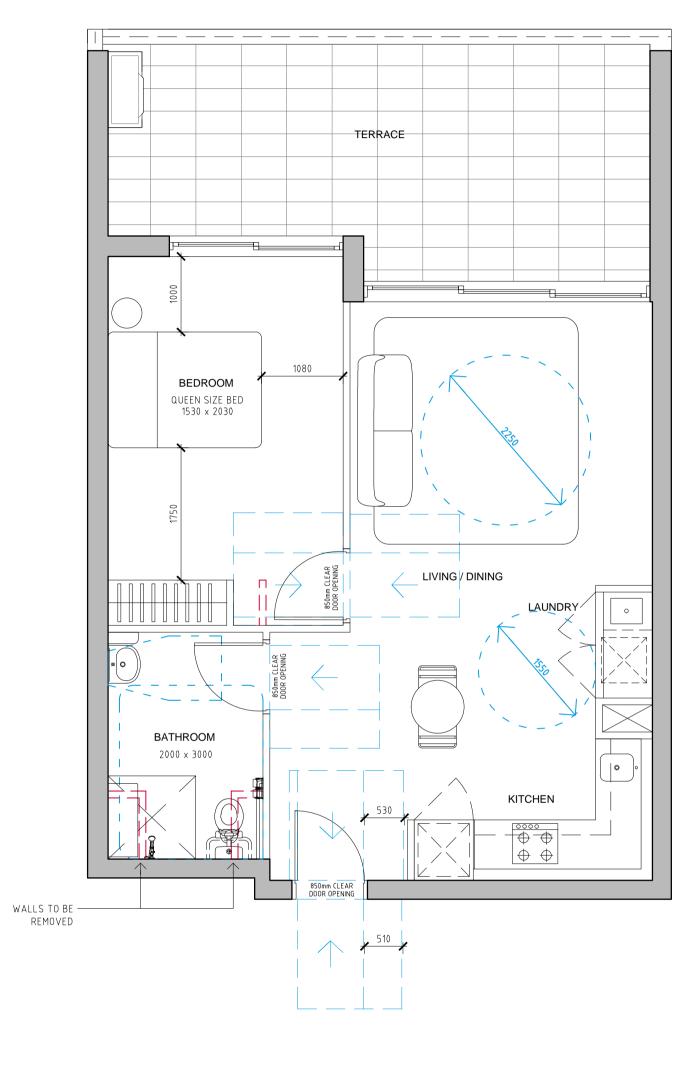ADAPTABLE UNIT: UNIT G01




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- POST-ADAPTATION LAYOUT
SCALE 1:50
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1 PRE-ADAPTATION LAYOUT - SCALE 1: 50
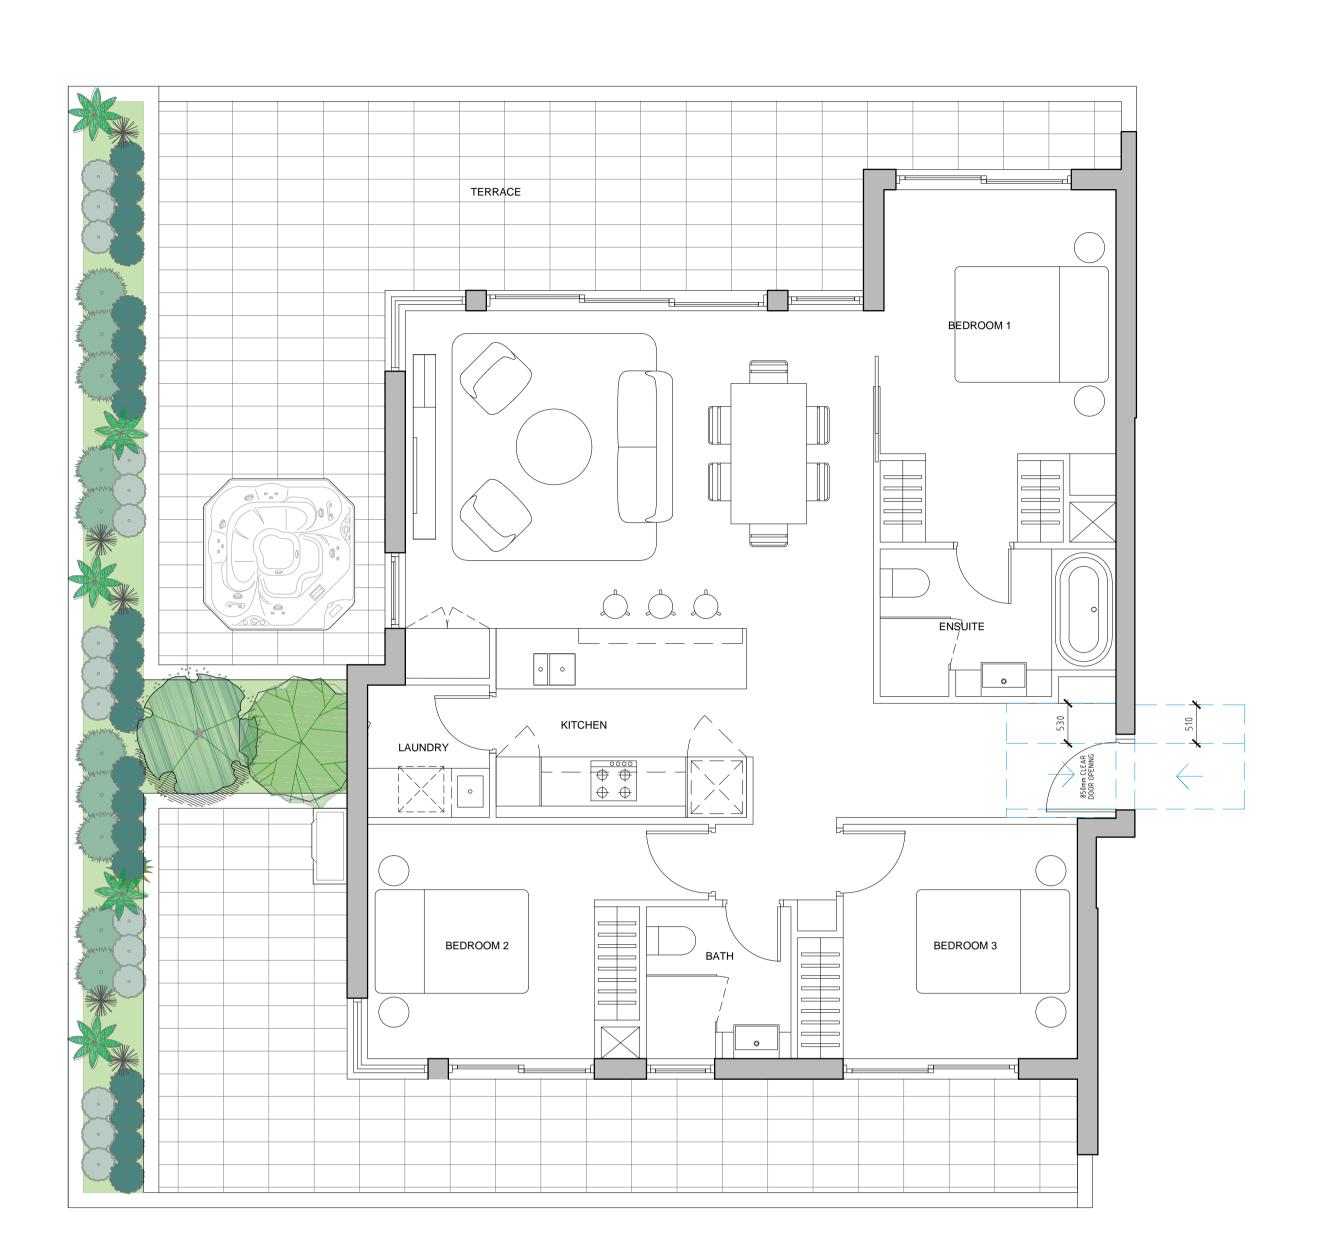
> ADAPTABLE UNIT: UNIT 403



2 POST-ADAPTATION LAYOUT SCALE 1 : 50

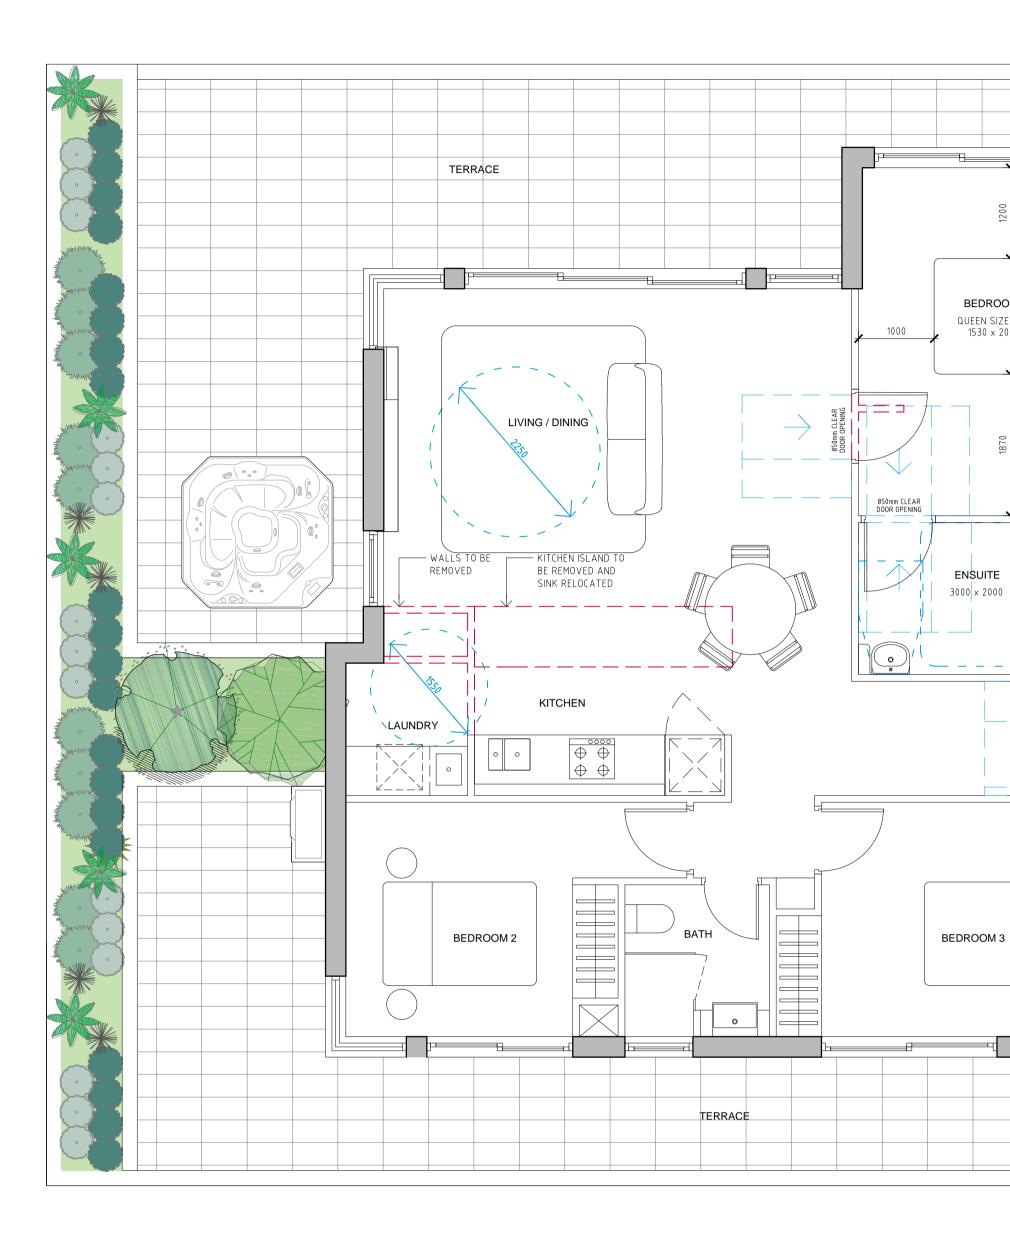